




ALLIANCE HOUSE

1805 S. MAIN STREET SALT LAKE CITY, UTAH

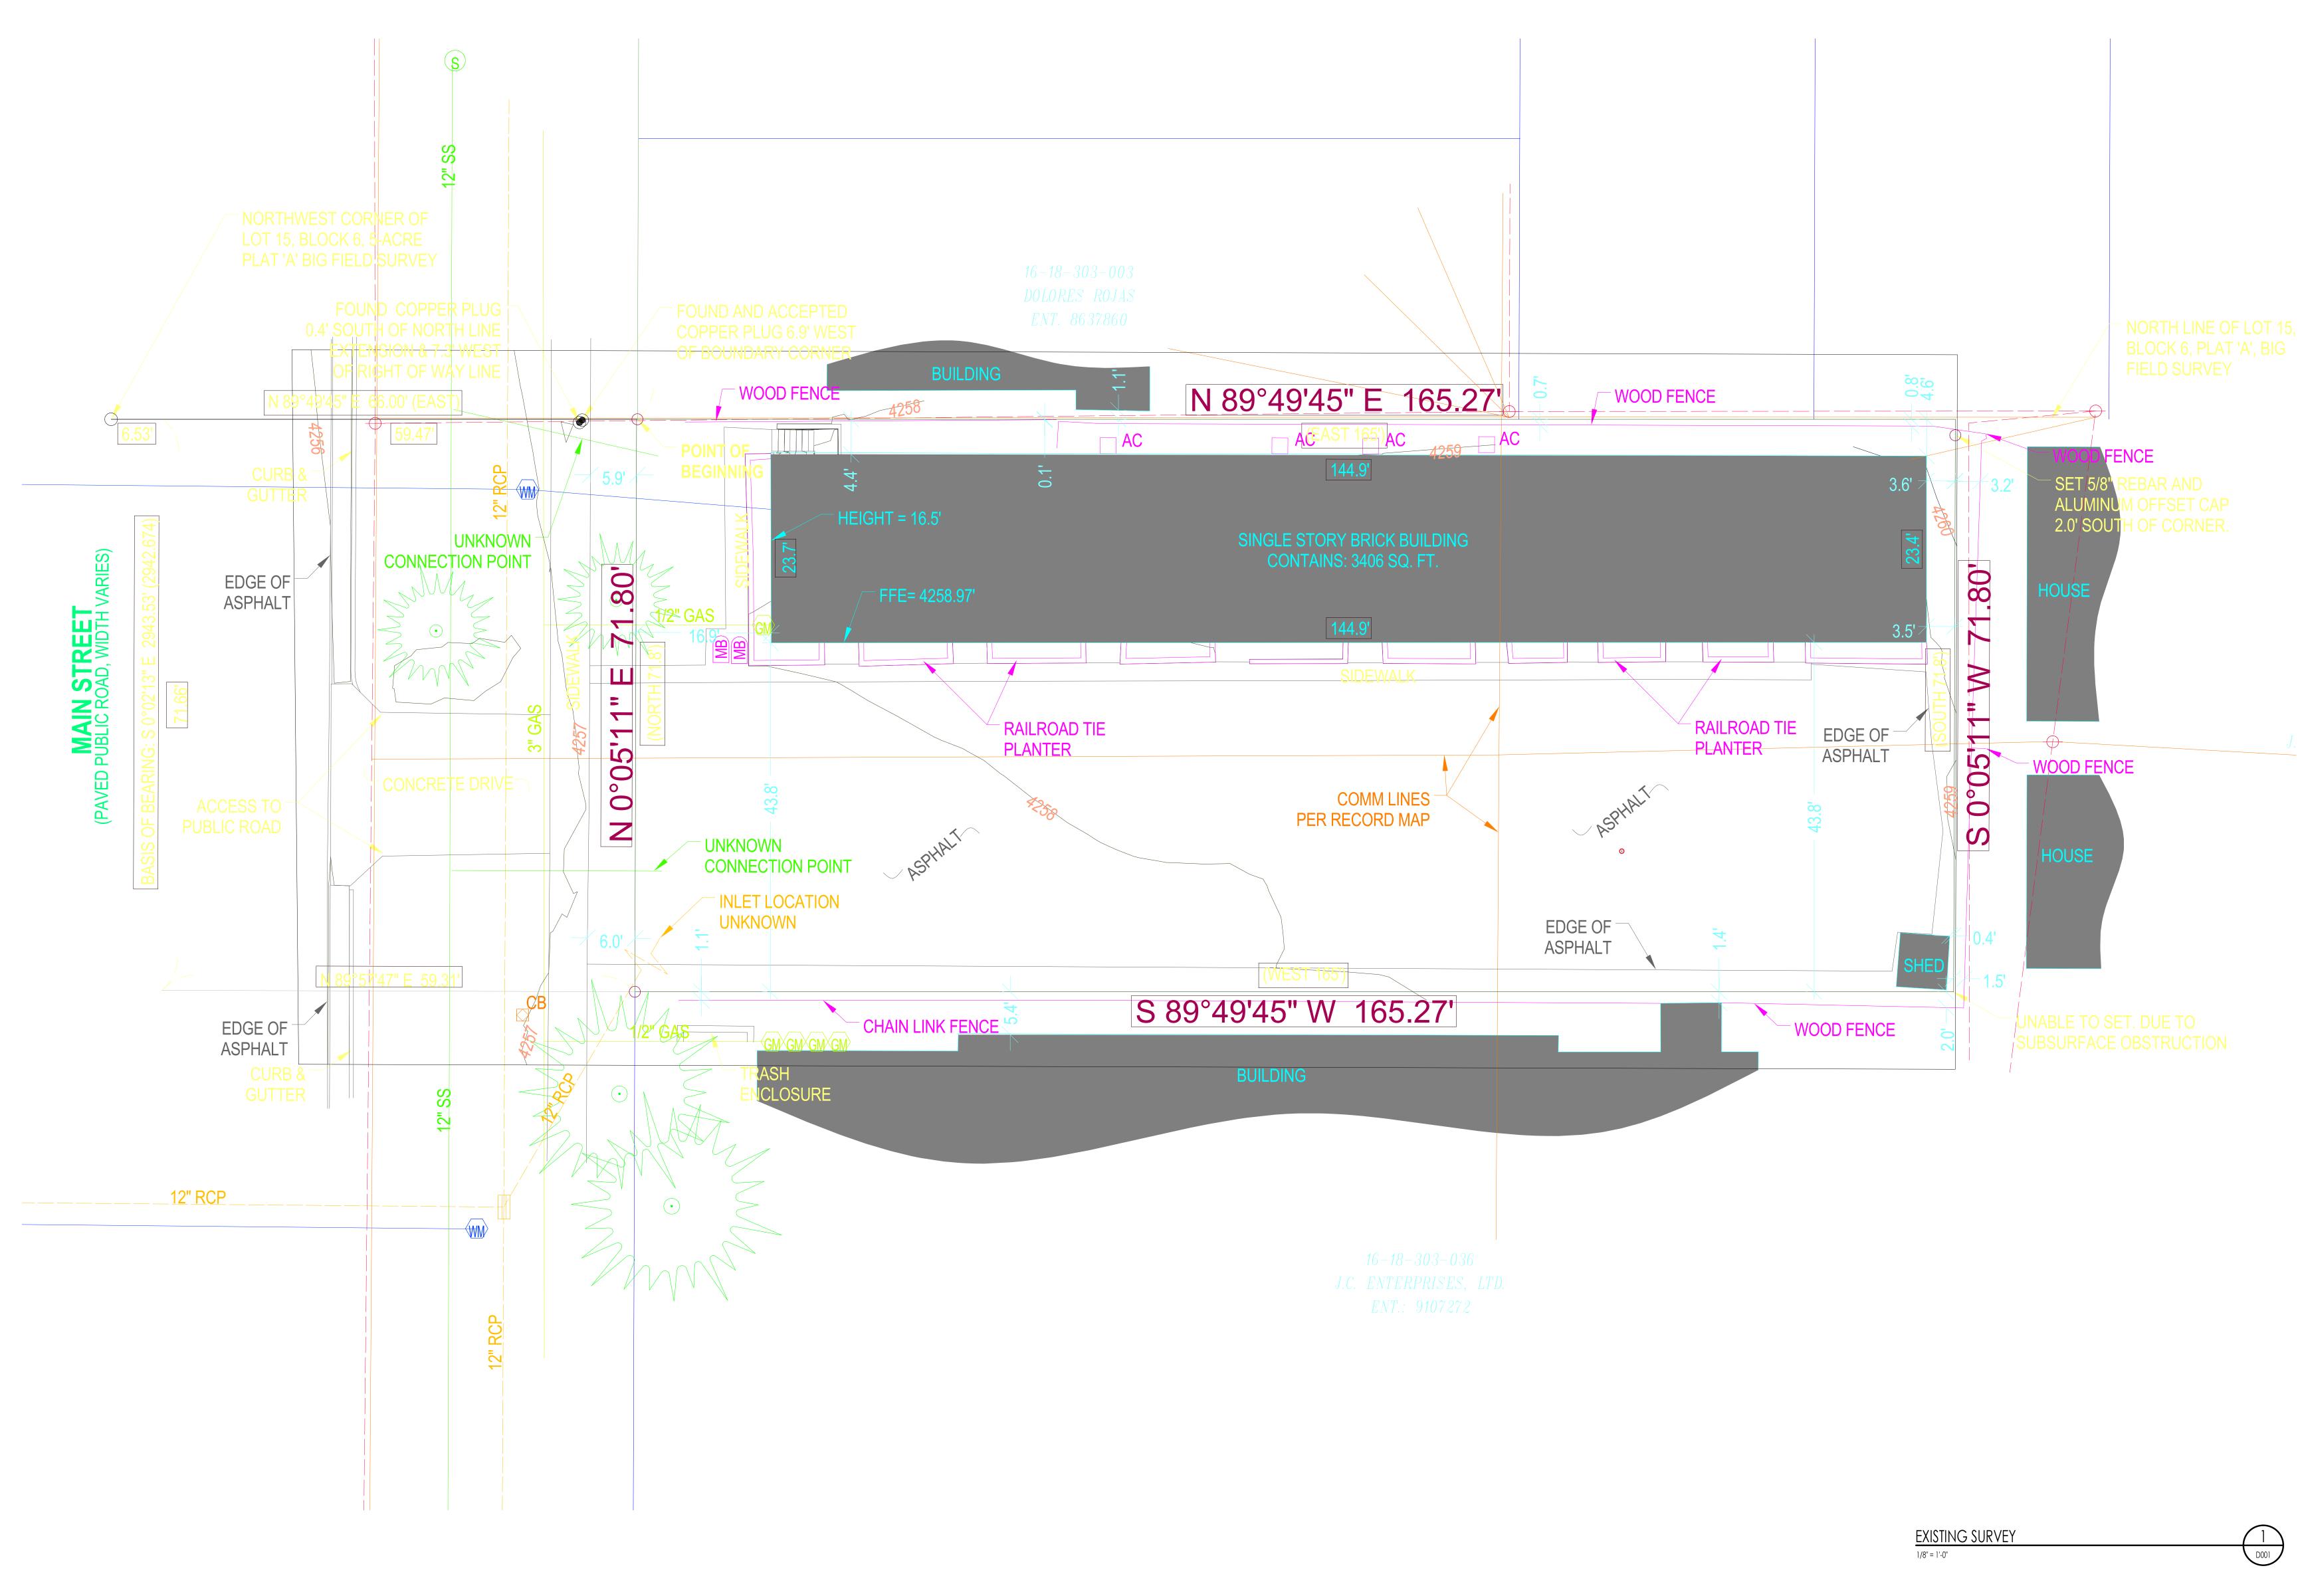






The designs shown and described herein including all technical drawings, graphic representation & models thereof, are the copyrighted work of Think Architecture, Inc. and & cannot be copied, duplicated, or commercially exploited in whole or in part without the sole and express written permission from THINK Architecture, Inc.



1805 S. MAIN STREET SALT LAKE CITY, UTAH

EXISTING SURVEY



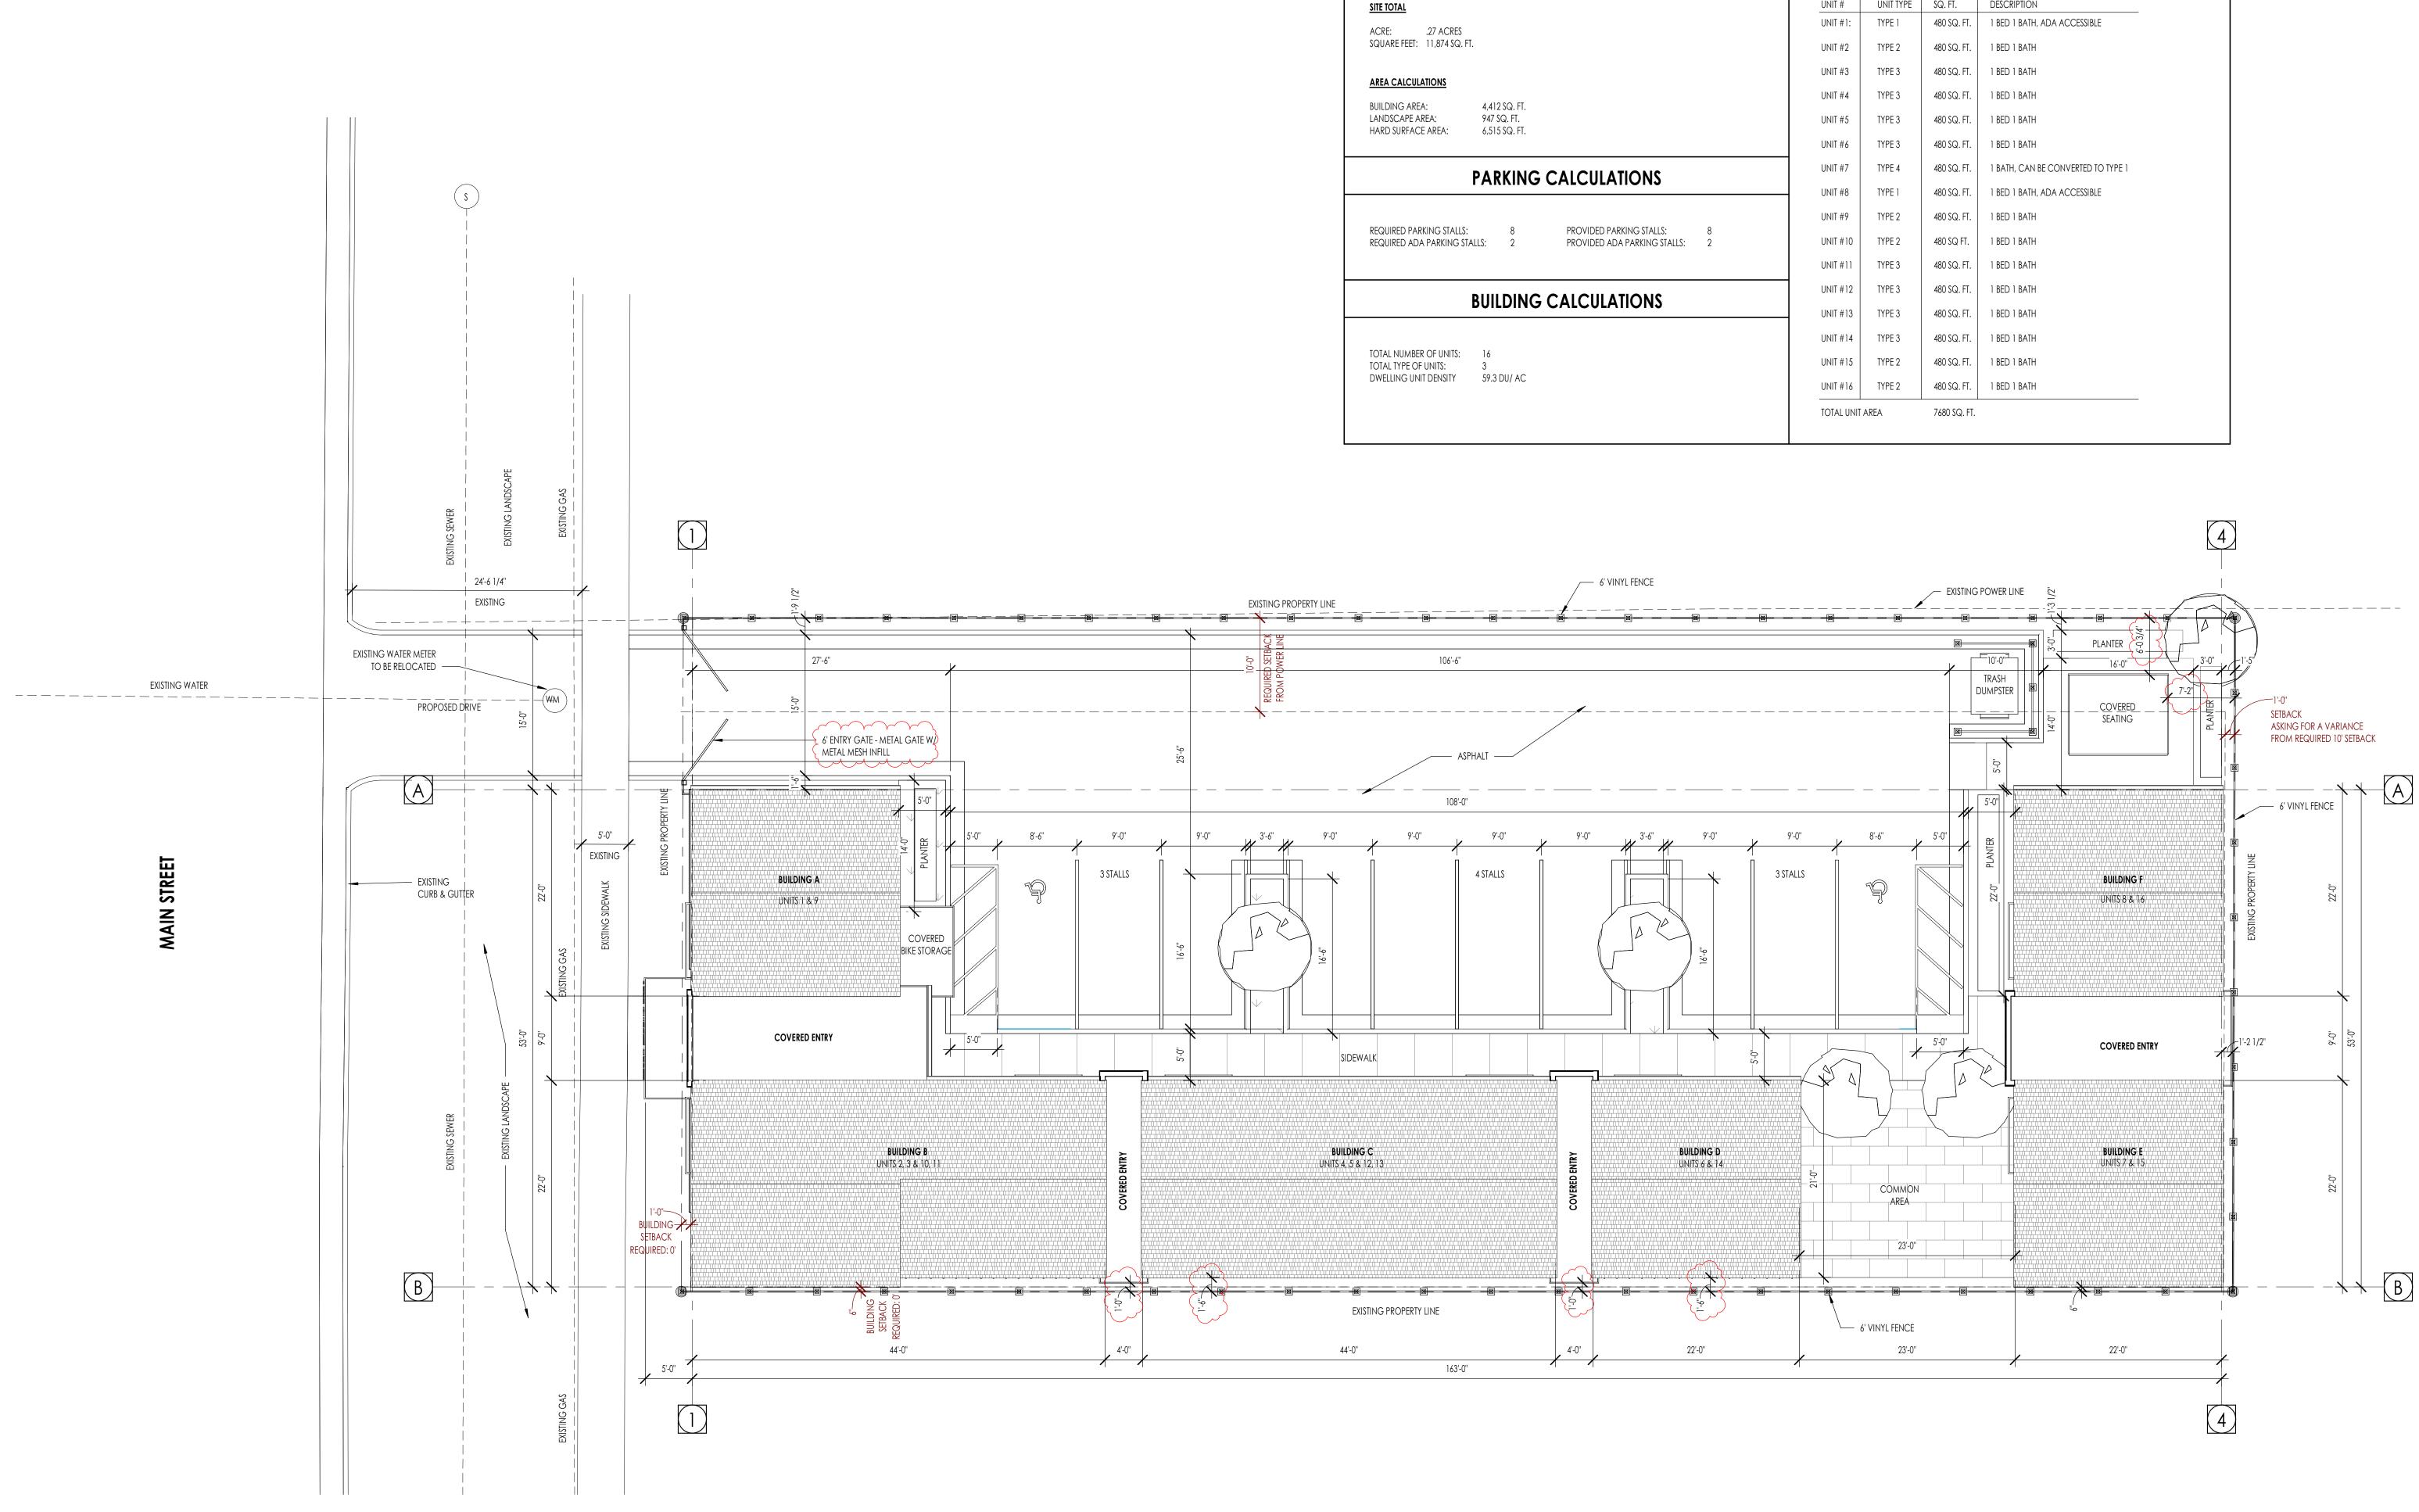

EXISTING WATER



The designs shown and described herein including all technical drawings, graphic representation & models thereof, are the copyrighted work of Think Architecture, Inc. and & cannot be copied, duplicated, or commercially exploited in whole or in part without the sole and express written permission from THINK Architecture, Inc.



LANDSCAPE ARCHITECT പ്പം

THINK ARCHITECTURE: 7927 SOUTH HIGH POINT WAY, SUITE 300 SANDY, UT 84094 801.269.0055

ALLIANCE HOUSE


Architecture

1805 S. MAIN STREET SALT LAKE CITY, UTAH

SITE AREA CALCULATIONS		BUILDING UNIT CALCULATIONS			
	UNIT #	UNIT TYPE	SQ. FT.	DESCRIPTION	
	UNIT #1:	TYPE 1	480 SQ. FT.	1 BED 1 BATH, ADA ACCESSIBLE	
res Sq. ft.	UNIT #2	TYPE 2	480 SQ. FT.	1 BED 1 BATH	
	UNIT #3	TYPE 3	480 SQ. FT.	1 BED 1 BATH	
	UNIT #4	TYPE 3	480 SQ. FT.	1 BED 1 BATH	
4,412 SQ. FT. 947 SQ. FT.	UNIT #5	TYPE 3	480 SQ. FT.	1 BED 1 BATH	
6,515 SQ. FT.	UNIT #6	TYPE 3	480 SQ. FT.	1 BED 1 BATH	
PARKING CALCULATIONS	UNIT #7	TYPE 4	480 SQ. FT.	1 BATH, CAN BE CONVERTED TO TYPE 1	
	UNIT #8	TYPE 1	480 SQ. FT.	1 bed 1 bath, ada accessible	
	UNIT #9	TYPE 2	480 SQ. FT.	1 BED 1 BATH	
ALLS:8PROVIDED PARKING STALLS:8IG STALLS:2PROVIDED ADA PARKING STALLS:2	UNIT #10	TYPE 2	480 SQ FT.	1 BED 1 BATH	
	UNIT #11	TYPE 3	480 SQ. FT.	1 BED 1 BATH	
BUILDING CALCULATIONS	UNIT #12	TYPE 3	480 SQ. FT.	1 BED 1 BATH	
DUILDING CALCULATIONS	UNIT #13	TYPE 3	480 SQ. FT.	1 BED 1 BATH	
	UNIT #14	TYPE 3	480 SQ. FT.	1 BED 1 BATH	
TS: 16 3	UNIT #15	TYPE 2	480 SQ. FT.	1 BED 1 BATH	
Y 59.3 DU/ AC	UNIT #16	TYPE 2	480 SQ. FT.	1 BED 1 BATH	
	TOTAL UNIT	AREA	7680 SQ. FT.		

CIVIL ENGINEER

MCNEIL ENGINEERING: TED DIDAS 8610 SANDY PARKWAY, SUITE 200 SANDY, UT 84070 801.255.7700

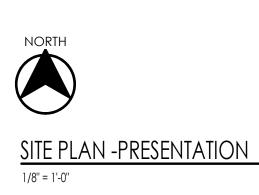


1 D002

SITE PLAN





and express written permission from THINK Architecture, Inc.

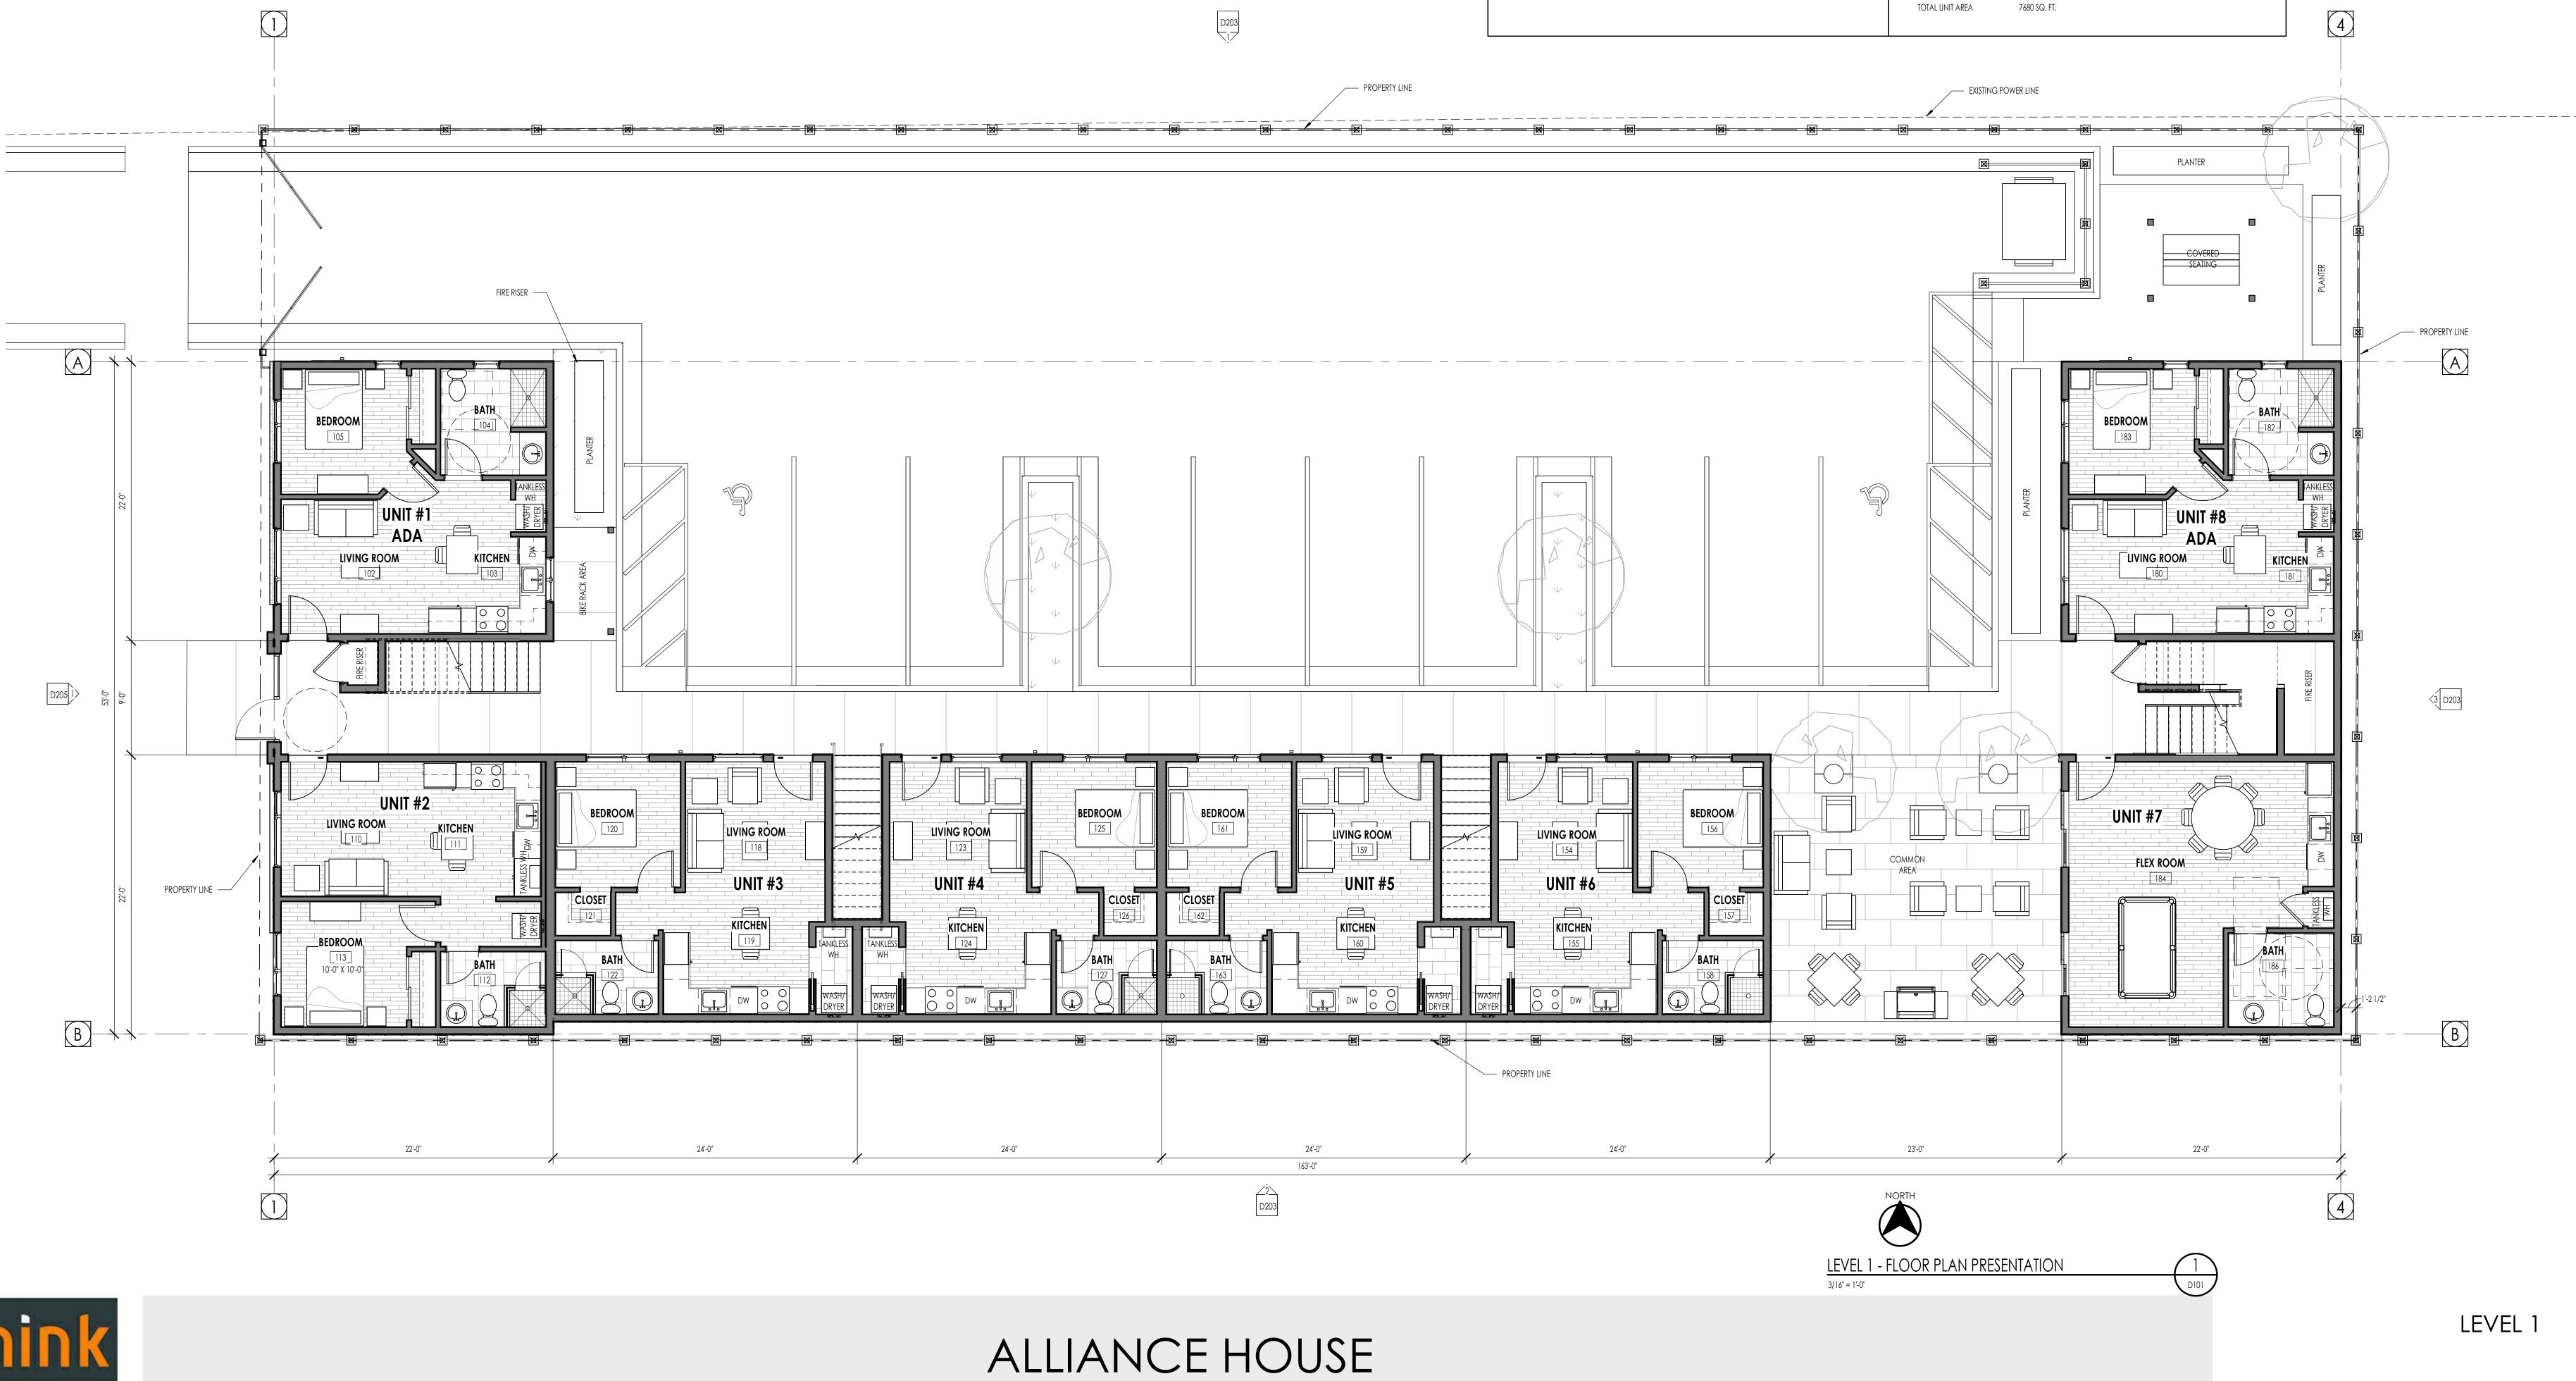

1805 S. MAIN STREET SALT LAKE CITY, UTAH

SITE AREA CALCULATIONS		BUILDING UNIT CALCULATIONS			
SITE TOTAL	UNIT #	UNIT TYPE	SQ. FT.	DESCRIPTION	
ACRE: .27 ACRES	UNIT #1:	TYPE 1	480 SQ. FT.	1 BED 1 BATH, ADA ACCESSIBLE	
SQUARE FEET: 11,874 SQ. FT.	UNIT #2	TYPE 2	480 SQ. FT.	1 BED 1 BATH	
AREA CALCULATIONS	UNIT #3	TYPE 3	480 SQ. FT.	1 BED 1 BATH	
BUILDING AREA: 4,412 SQ. FT.	UNIT #4	TYPE 3	480 SQ. FT.	1 BED 1 BATH	
LANDSCAPE AREA: 947 SQ. FT. HARD SURFACE AREA: 6,515 SQ. FT.	UNIT #5	TYPE 3	480 SQ. FT.	1 BED 1 BATH	
HARD SURFACE AREA. 0,313 SQ. FI.	UNIT #6	TYPE 3	480 SQ. FT.	1 BED 1 BATH	
PARKING CALCULATIONS	UNIT #7	TYPE 4	480 SQ. FT.	1 BATH, CAN BE CONVERTED TO TYPE 1	
	UNIT #8	TYPE 1	480 SQ. FT.	1 BED 1 BATH, ADA ACCESSIBLE	
	UNIT #9	TYPE 2	480 SQ. FT.	1 BED 1 BATH	
REQUIRED PARKING STALLS:8PROVIDED PARKING STALLS:8REQUIRED ADA PARKING STALLS:2PROVIDED ADA PARKING STALLS:2	UNIT #10	TYPE 2	480 SQ FT.	1 BED 1 BATH	
	UNIT #11	TYPE 3	480 SQ. FT.	1 BED 1 BATH	
BUILDING CALCULATIONS	UNIT #12	TYPE 3	480 SQ. FT.	1 BED 1 BATH	
DUILDING CALCULATIONS	UNIT #13	TYPE 3	480 SQ. FT.	1 BED 1 BATH	
	UNIT #14	TYPE 3	480 SQ. FT.	1 BED 1 BATH	
IOTAL NUMBER OF UNITS: 16 IOTAL TYPE OF UNITS: 3	UNIT #15	TYPE 2	480 SQ. FT.	1 BED 1 BATH	
DWELLING UNIT DENSITY 59.3 DU/ AC	UNIT #16	TYPE 2	480 SQ. FT.	1 BED 1 BATH	
	TOTAL UNIT	AREA	7680 SQ. FT.		







and express written permission from THINK Architecture, Inc.

SITE TOTAL ACRE: .27 ACRES SQUARE FEET: 11,874 SQ. AREA CALCULATIONS BUILDING AREA: LANDSCAPE AREA: HARD SURFACE AREA: REQUIRED PARKING STALI REQUIRED ADA PARKING

TOTAL NUMBER OF UNITS: TOTAL TYPE OF UNITS: DWELLING UNIT DENSITY


ALLIANCE HOUSE

1805 S. MAIN STREET SALT LAKE CITY, UTAH

SITE AREA CALCULATIONS		BUI	LDING L	INIT CALCULATIONS
	UNIT #	UNIT TYPE	SQ. FT.	DESCRIPTION
RES	UNIT #1:	TYPE 1	480 SQ. FT.	1 BED 1 BATH, ADA ACCESSIBLE
Q. FT.	UNIT #2	TYPE 2	480 SQ. FT.	1 BED 1 BATH
	UNIT #3	TYPE 3	480 SQ. FT.	1 BED 1 BATH
	UNIT #4	TYPE 3	480 SQ. FT.	1 BED 1 BATH
4,412 SQ. FT. 947 SQ. FT.	UNIT #5	TYPE 3	480 SQ. FT.	1 BED 1 BATH
6,515 SQ. FT.	UNIT #6	TYPE 3	480 SQ. FT.	1 BED 1 BATH
PARKING CALCULATIONS	UNIT #7	TYPE 4	480 SQ. FT.	1 BATH, CAN BE CONVERTED TO TYPE
	UNIT #8	TYPE 1	480 SQ. FT.	1 BED 1 BATH, ADA ACCESSIBLE
8 PROVIDED PARKING STALLS: 8	UNIT #9	TYPE 2	480 SQ. FT.	1 BED 1 BATH
8PROVIDED PARKING STALLS:8ALLS:2PROVIDED ADA PARKING STALLS:2	UNIT #10	TYPE 2	480 SQ FT.	1 BED 1 BATH
	UNIT #11	TYPE 3	480 SQ. FT.	1 BED 1 BATH
	UNIT #12	TYPE 3	480 SQ. FT.	1 BED 1 BATH
BUILDING CALCULATIONS	UNIT #13	TYPE 3	480 SQ. FT.	1 BED 1 BATH
	UNIT #14	TYPE 3	480 SQ. FT.	1 BED 1 BATH
16 3	UNIT #15	TYPE 2	480 SQ. FT.	1 BED 1 BATH
59.3 DU/ AC	UNIT #16	TYPE 2	480 SQ. FT.	1 BED 1 BATH
	TOTAL UNIT	AREA	7680 SQ. FT.	

LEVEL 2



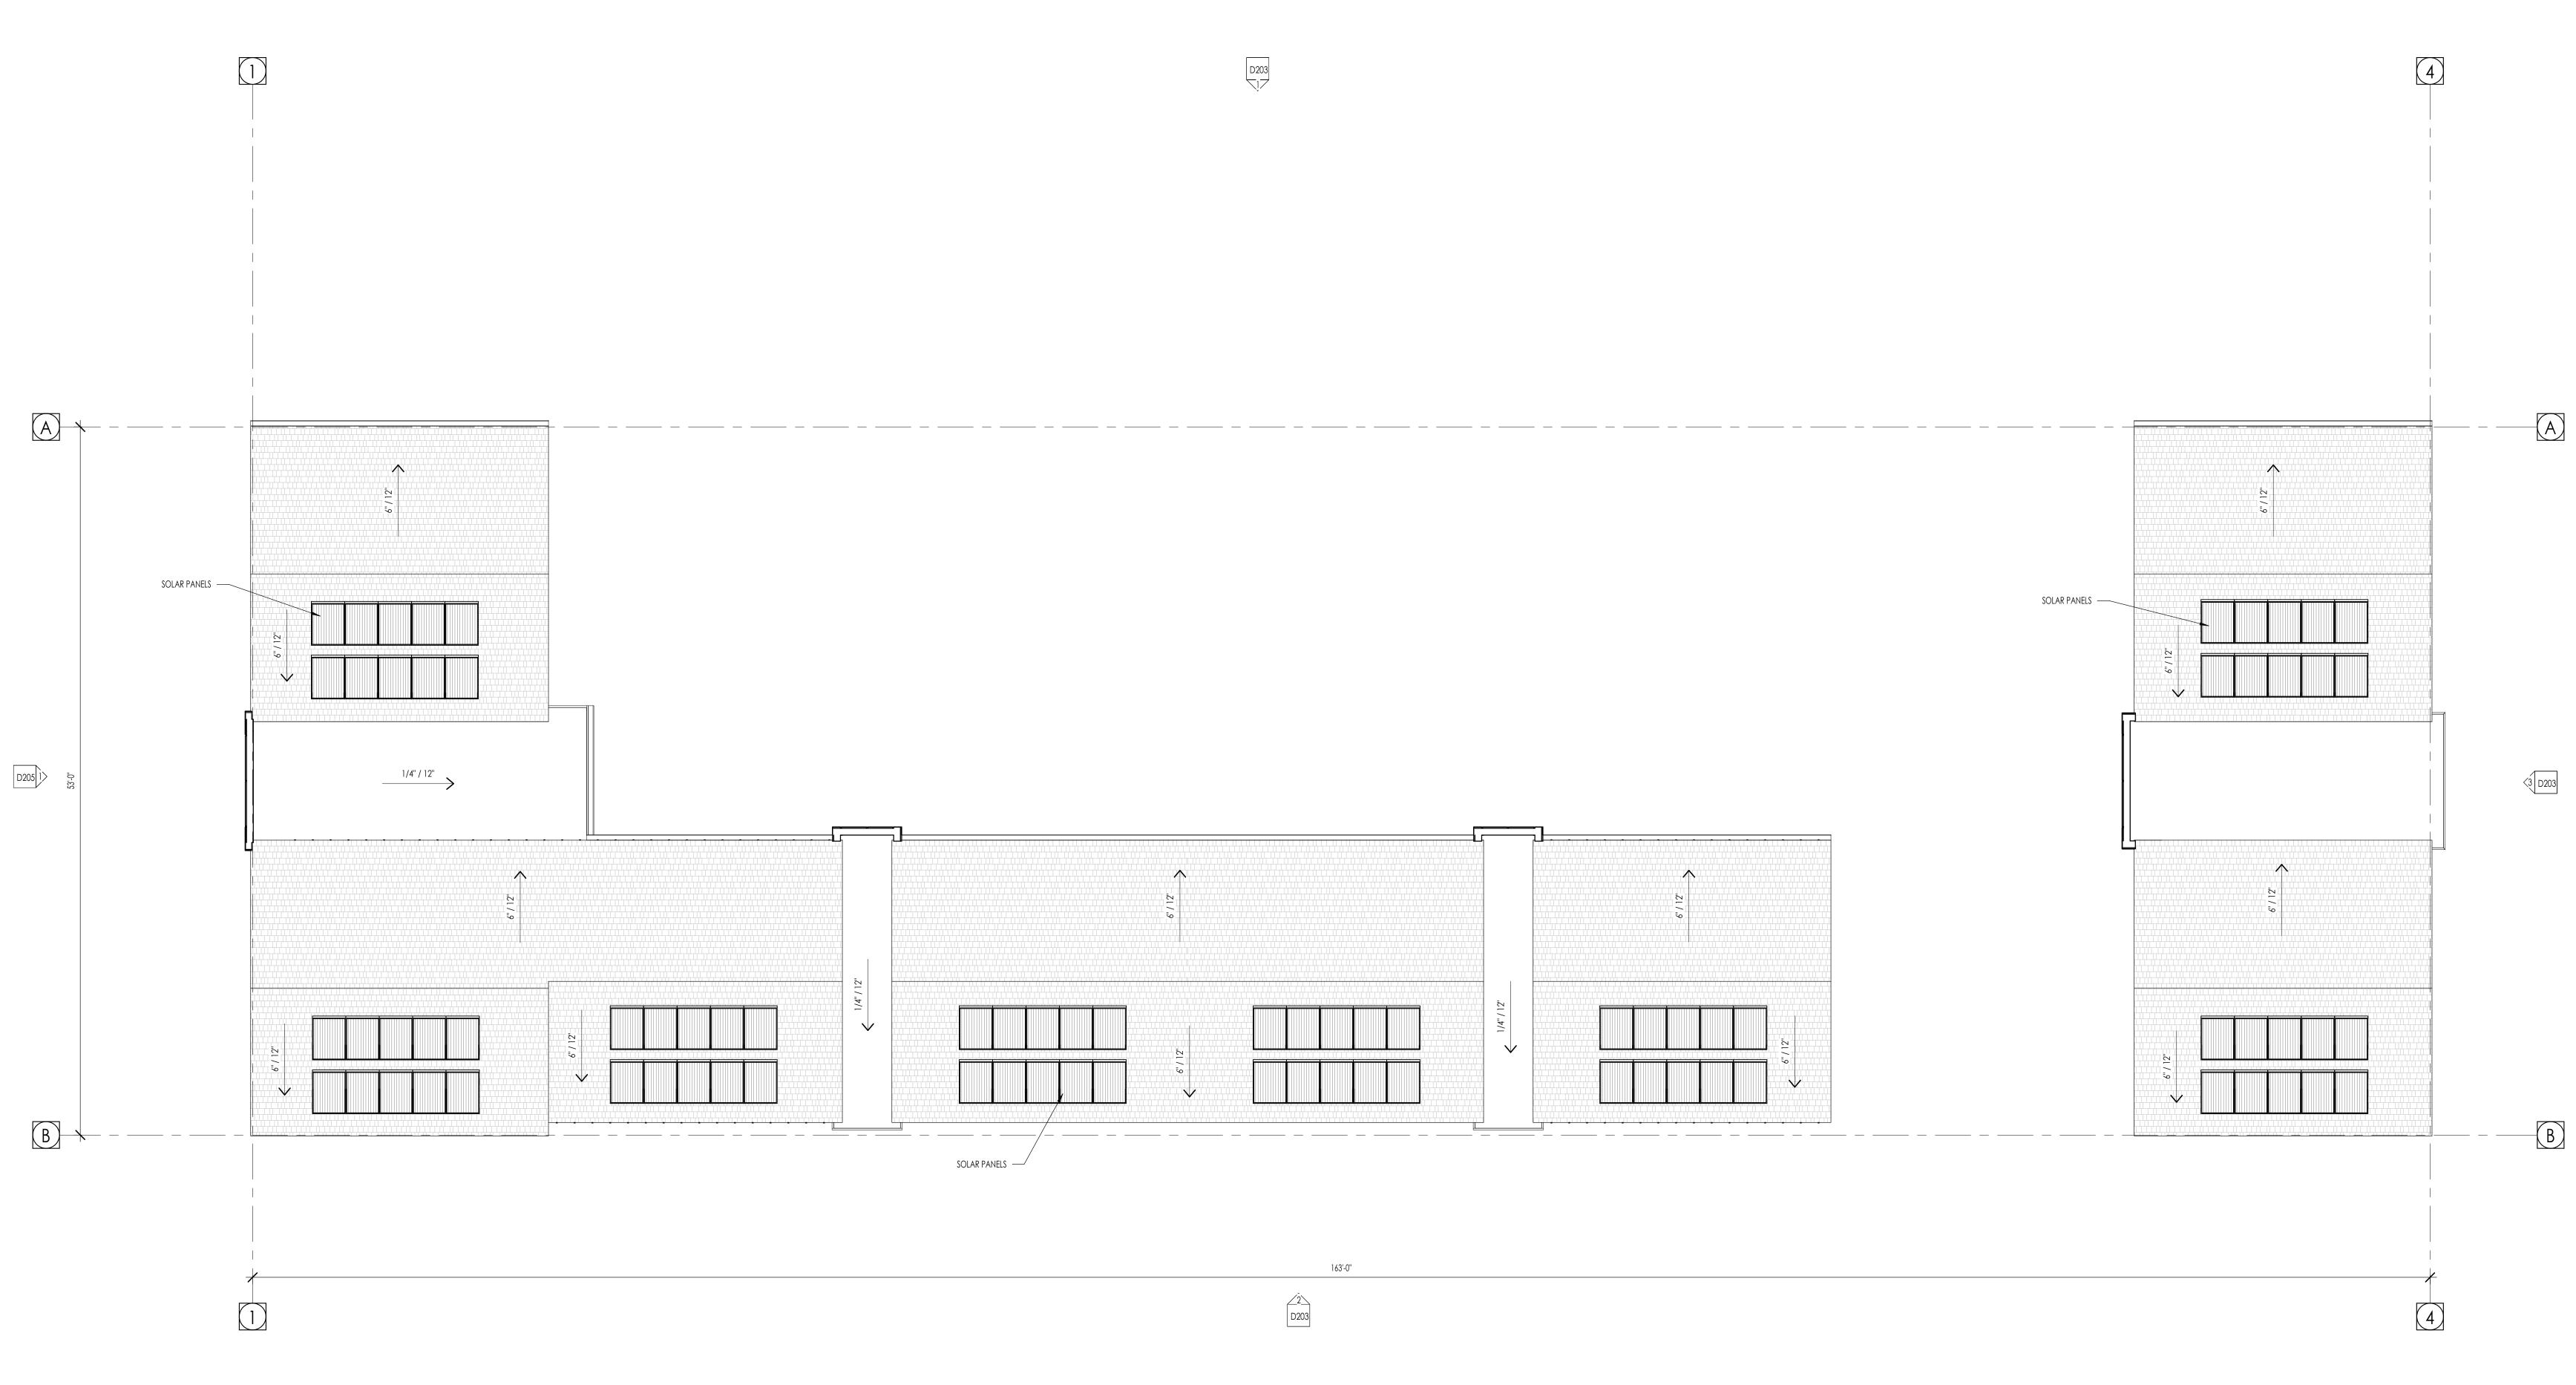



ALLIANCE HOUSE

1805 S. MAIN STREET SALT LAKE CITY, UTAH

1 D103 **ROOF PLAN - PRESENTATION** 3/16" = 1'-0"

ROOF PLAN









The designs shown and described herein including all technical drawings, graphic representation & models thereof, are the copyrighted work of Think Architecture, Inc. and & cannot be copied, duplicated, or commercially exploited in whole or in part without the sole and express written permission from THINK Architecture, Inc.

ALLIANCE HOUSE

1805 S. MAIN STREET SALT LAKE CITY, UTAH





EXTERIOR VIEWS








The designs shown and described herein including all technical drawings, graphic representation & models thereof, are the copyrighted work of Think Architecture, Inc. and & cannot be copied, duplicated, or commercially exploited in whole or in part without the sole and express written permission from THINK Architecture, Inc.



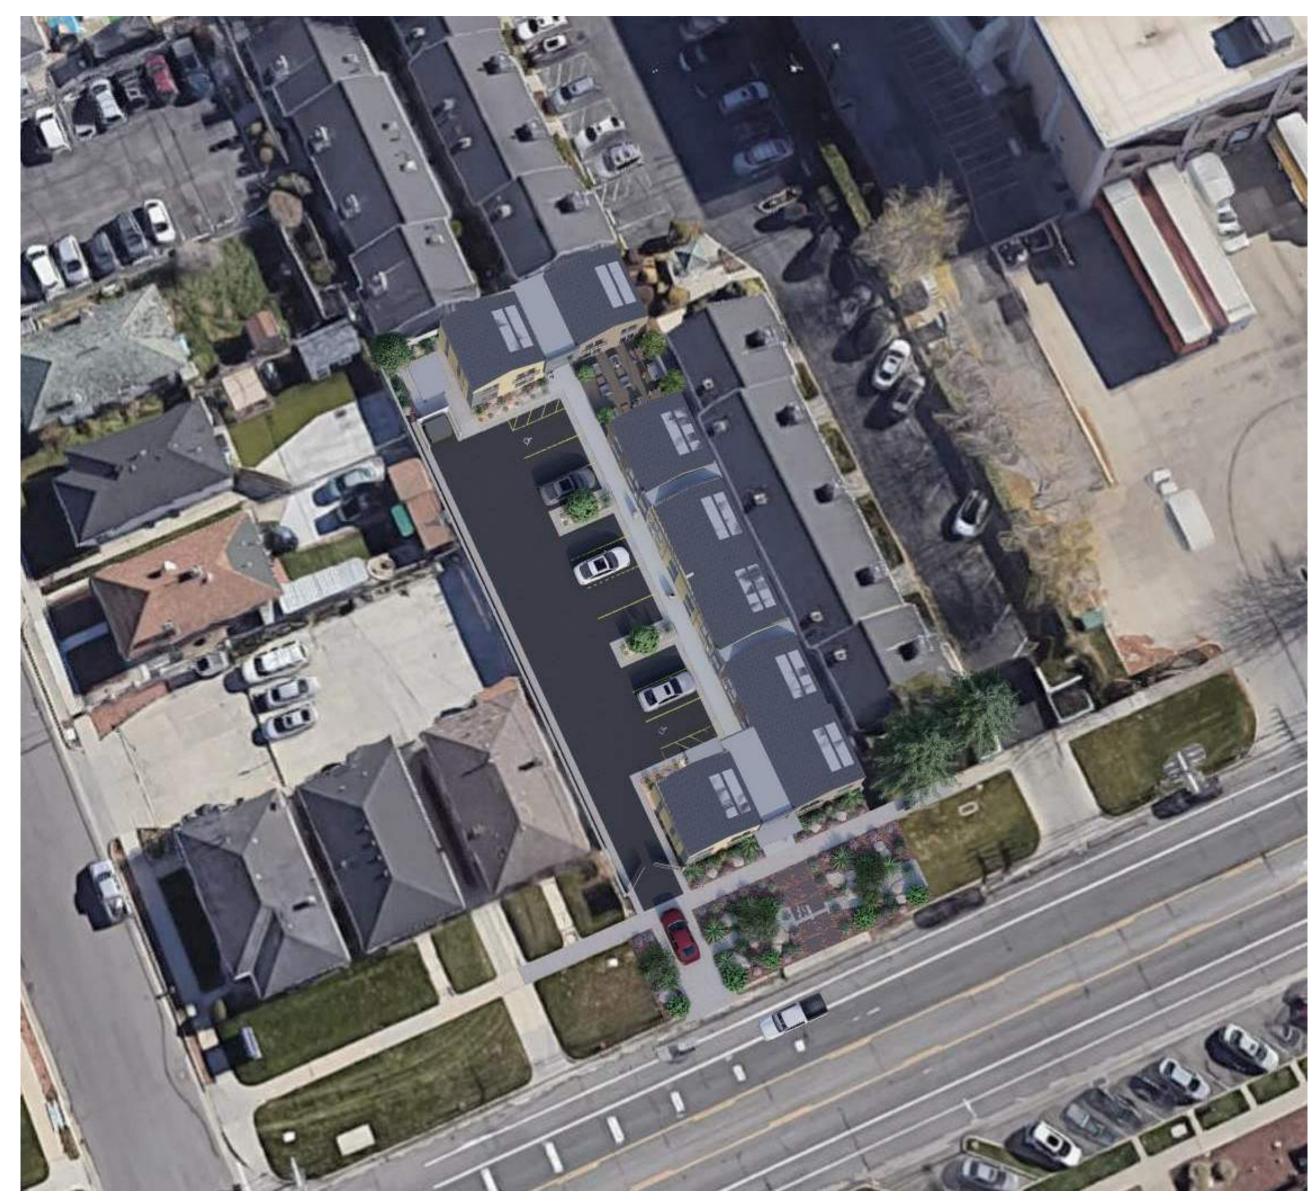


ALLIANCE HOUSE


1805 S. MAIN STREET SALT LAKE CITY, UTAH

EXTERIOR VIEWS





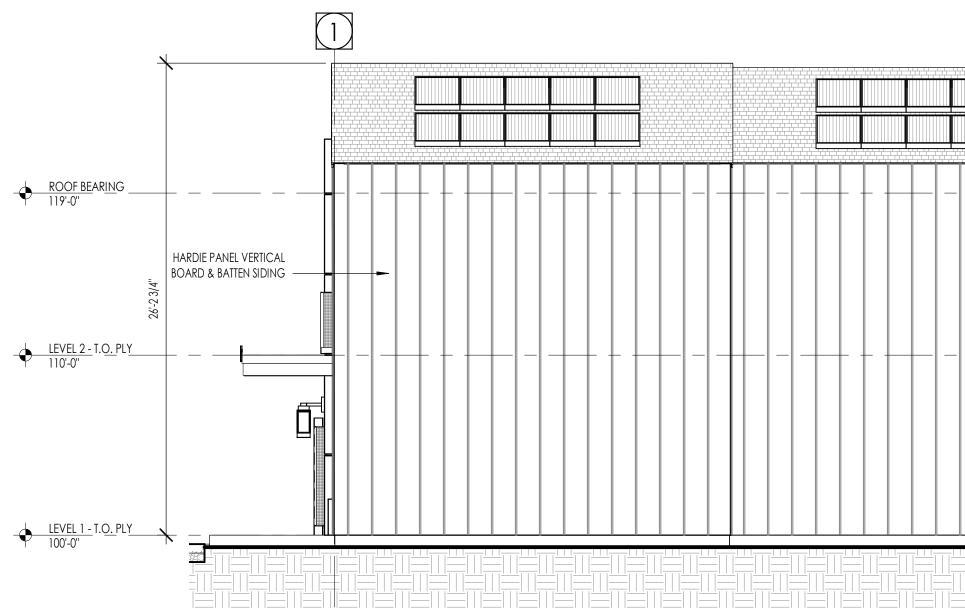


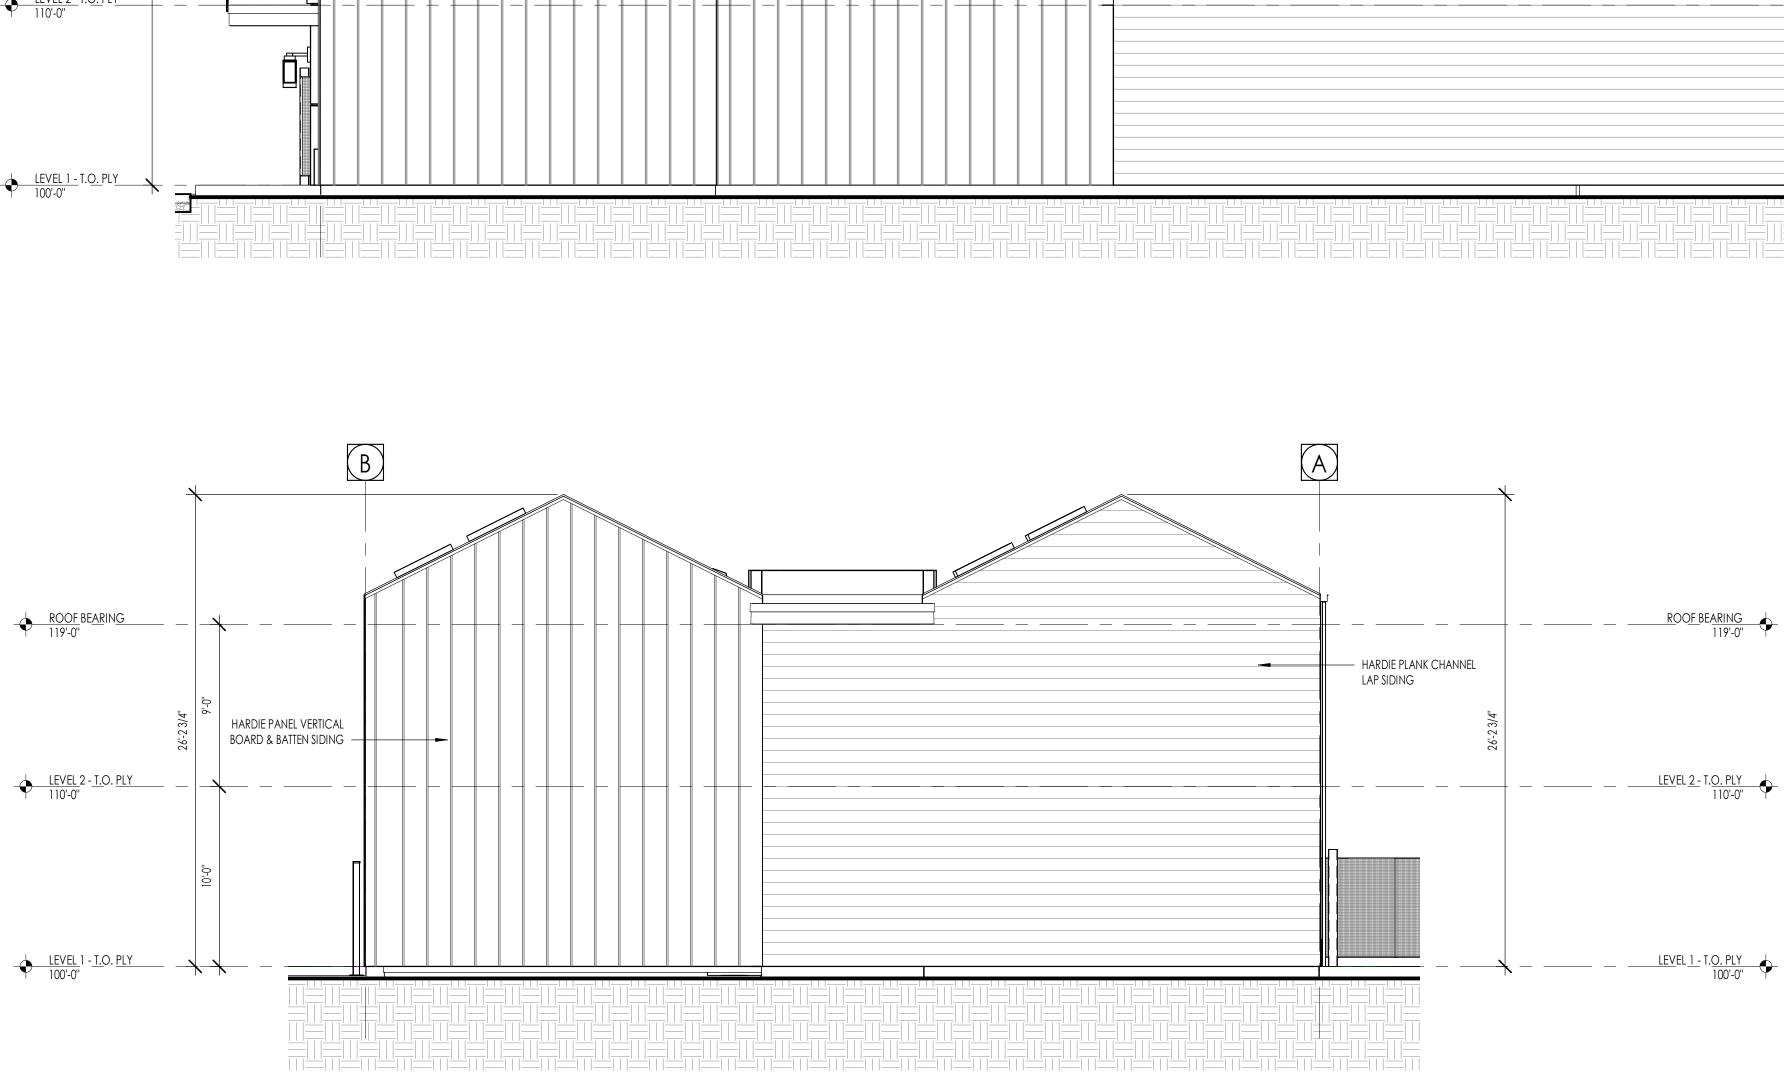



cannot be copied, duplicated, or commercially exploited in whole or in part without the sole


and express written permission from THINK Architecture, Inc.

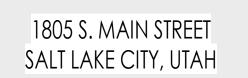


ALLIANCE HOUSE

<u>ROOF BEARING</u> 119'-0''

LEVEL 2 - T.O. PLY 110'-0"

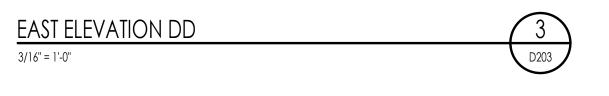

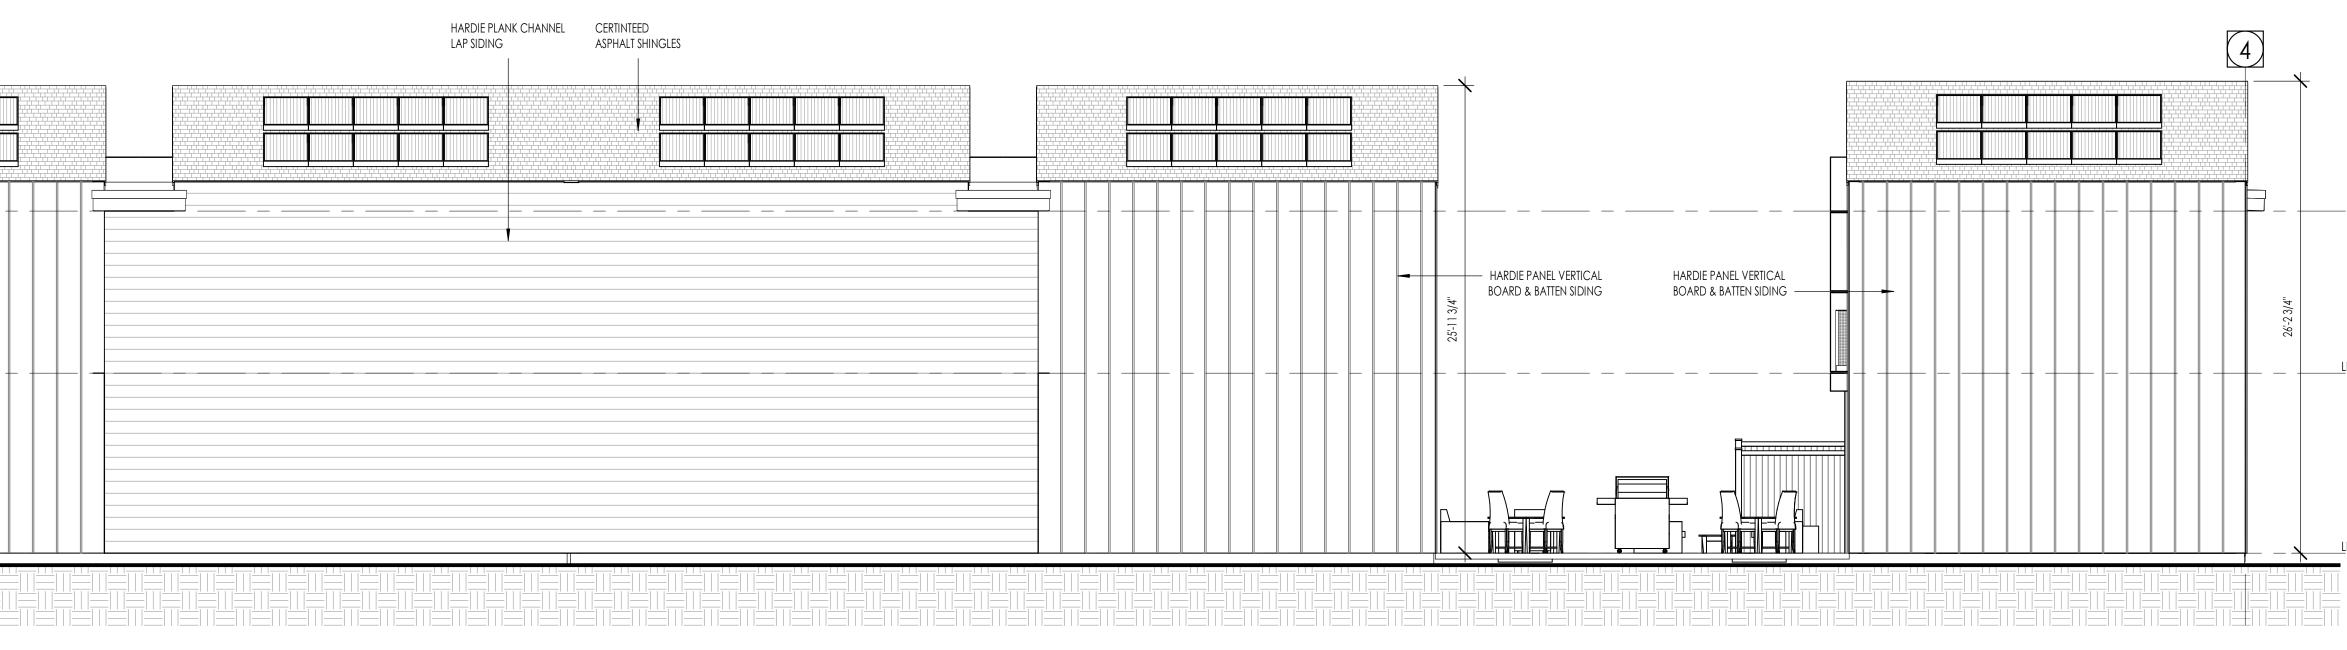

• <u>ROOF BEARING</u> _____

← <u>LEVEL 2 -</u> T.<u>O.</u> PLY 110'-0"

• <u>LEVEL 1 - T.O. PLY</u>

HARDIE PLANK CHANNEL LAP SIDING

Hardie Architectural Panel -


NORTH ELEVATION DD 3/16" = 1'-0"

SOUTH ELEVATION DD



WEST ELEVATION DD

3/16" = 1'-0"

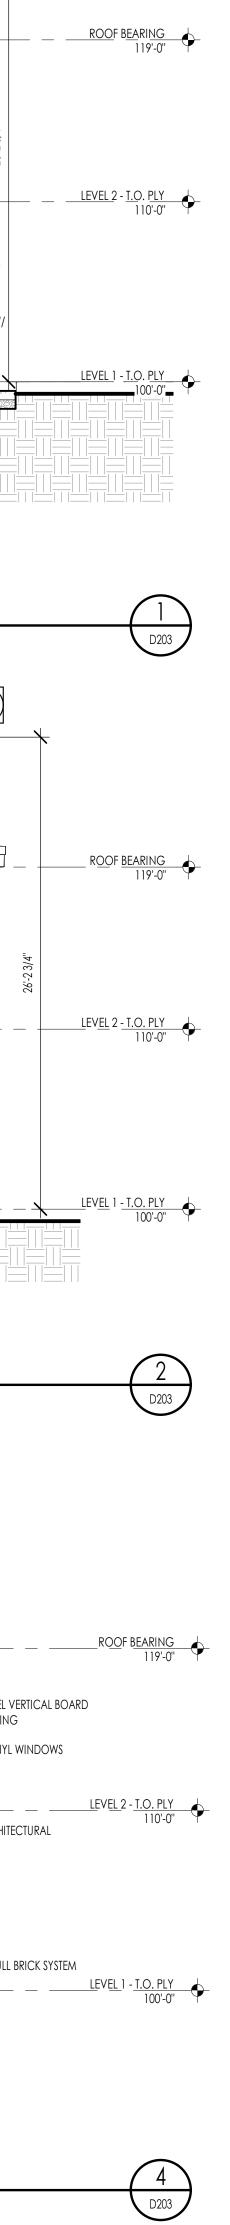


EXTERIOR ELEVATIONS







HARDIE PLANK CHANNEL LAP SIDING COLOR: BENJAMIN MOORE - CONCORD IVORY OR SIMILAR APPROVED COLOR

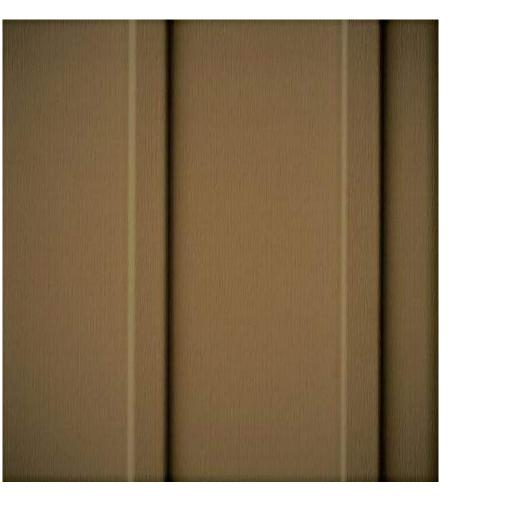


HARDIE PANEL VERTICAL BOARD & BATTEN SIDING COLOR: BENJAMIN MOORE - TOASTED MARSHMALLOW OR SIMILAR APPROVED COLOR





The designs shown and described herein including all technical drawings, graphic representation & models thereof, are the copyrighted work of Think Architecture, Inc. and & cannot be copied, duplicated, or commercially exploited in whole or in part without the sole and express written permission from THINK Architecture, Inc.



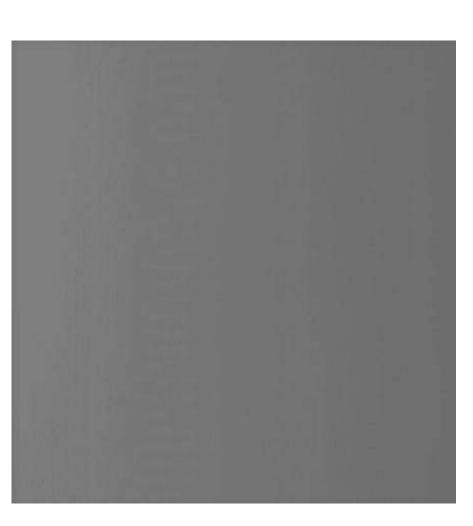


HARDIE ARCHITECTURAL PANEL TYPE: FINE SAND COLOR: BENJAMIN MOORE - CINDER OR SIMILAR APPROVED COLOR



MASONRY FULL BRICK SYSTEM TYPE: 'IINTERSTATE BRICK' FACE BRICK - DARTMOUTH OR SIMILAR APPROVED TYPE



EXTERIOR VINYL WINDOWS COLOR: BENJAMIN MOORE - CINDER OR SIMILAR APPROVED COLOR

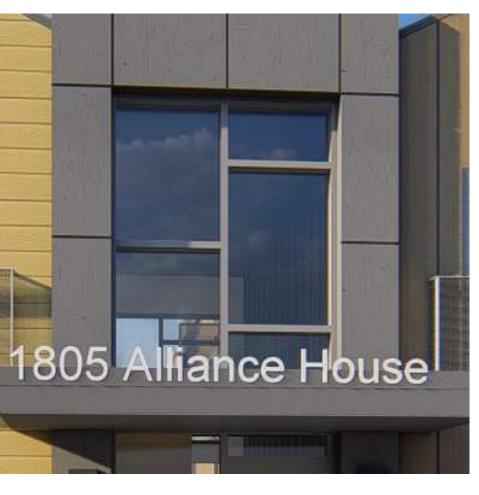


EXTERIOR ALUMINUM STOREFRONT SYSTEMS COLOR: BENJAMIN MOORE - CINDER OR SIMILAR APPROVED COLOR

ALLIANCE HOUSE

1805 S. MAIN STREET SALT LAKE CITY, UTAH



HARDIE TRIM BOARD trim & fascia COLOR: BENJAMIN MOORE - CINDER OR SIMILAR APPROVED COLOR

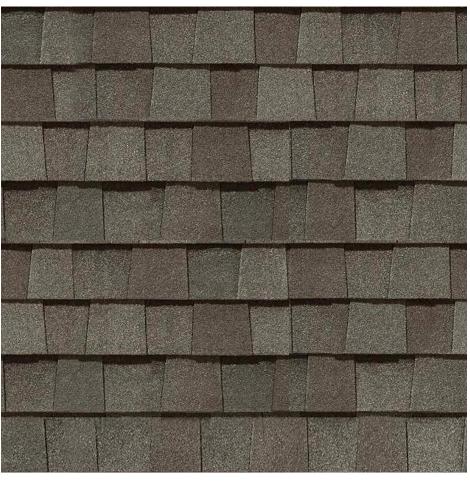

CETINTEED ASPHALT SHINGLES ROOFING SYSTEM COLOR: WEATHERED WOOD








COLOR LEGEND		GLASS PERCENTAGE CALCULATION
HATCH	DESCRIPTION	
	GLASS EXTERIOR WALL	EXTERIOR WALL: 848 SQ. FT. GLASS: 372 SQ. FT. TOTAL: 1,220 SQ. FT.
		GLASS PERCENTAGE: 30%








Architecture Interior Design Landscape Architecture Land Planning Construction Management

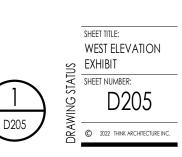

D205

REVISIONS:

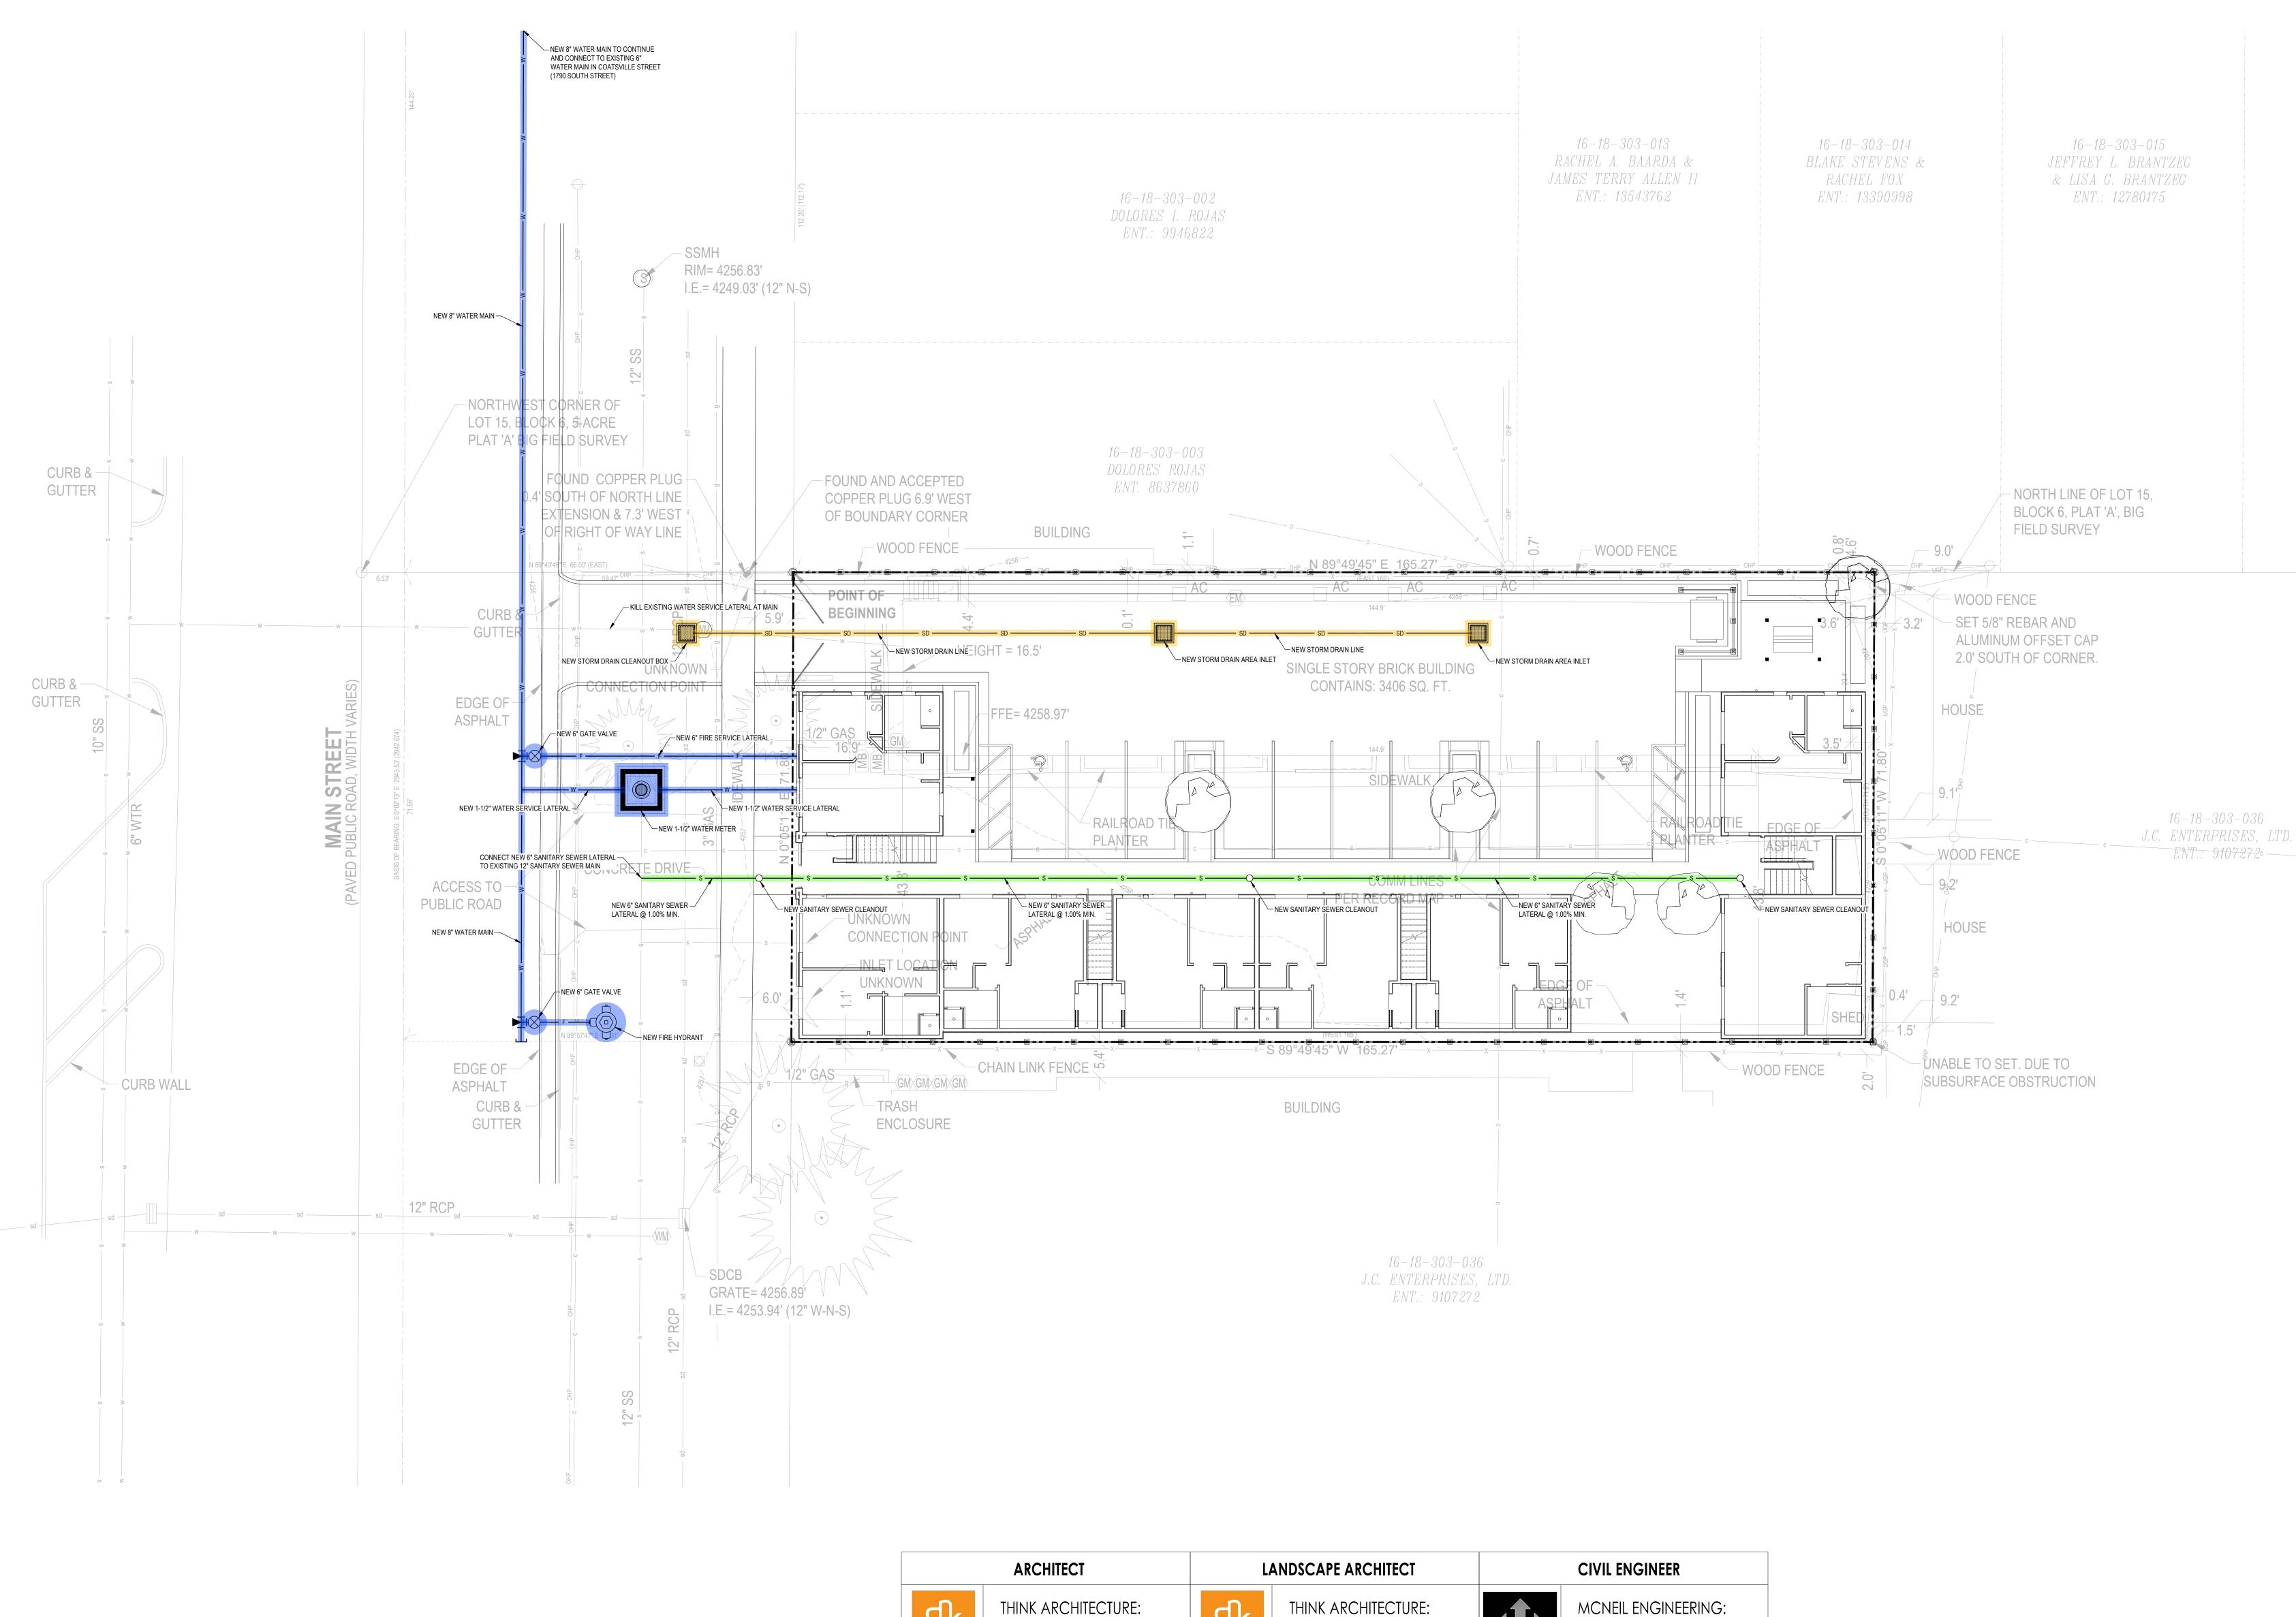



The designs shown and described herein including all technical drawings, graphic representation & models thereof, are the copyrighted work of Think Architecture, Inc. and & cannot be copied, duplicated, or commercially exploited in whole or in part without the sole and express written permission from THINK Architecture, Inc.

THINK ARCHITECTURE: 7927 South High Point Way, suite 300 SANDY, UT 84094 801.269.0055

ALLIANCE HOUSE

<u>ط</u>

Architecture

E


Architecture

7927 South High Point Way, suite 300

SANDY, UT 84094

801.269.0055

1805 S. MAIN STREET SALT LAKE CITY, UTAH

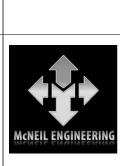



MCNEIL ENGINEERING: ied didas 8610 Sandy Parkway, Suite 200 SANDY, UT 84070 801.255.7700

CONCEPTUAL CIVIL SITE PLAN

1" = 10'



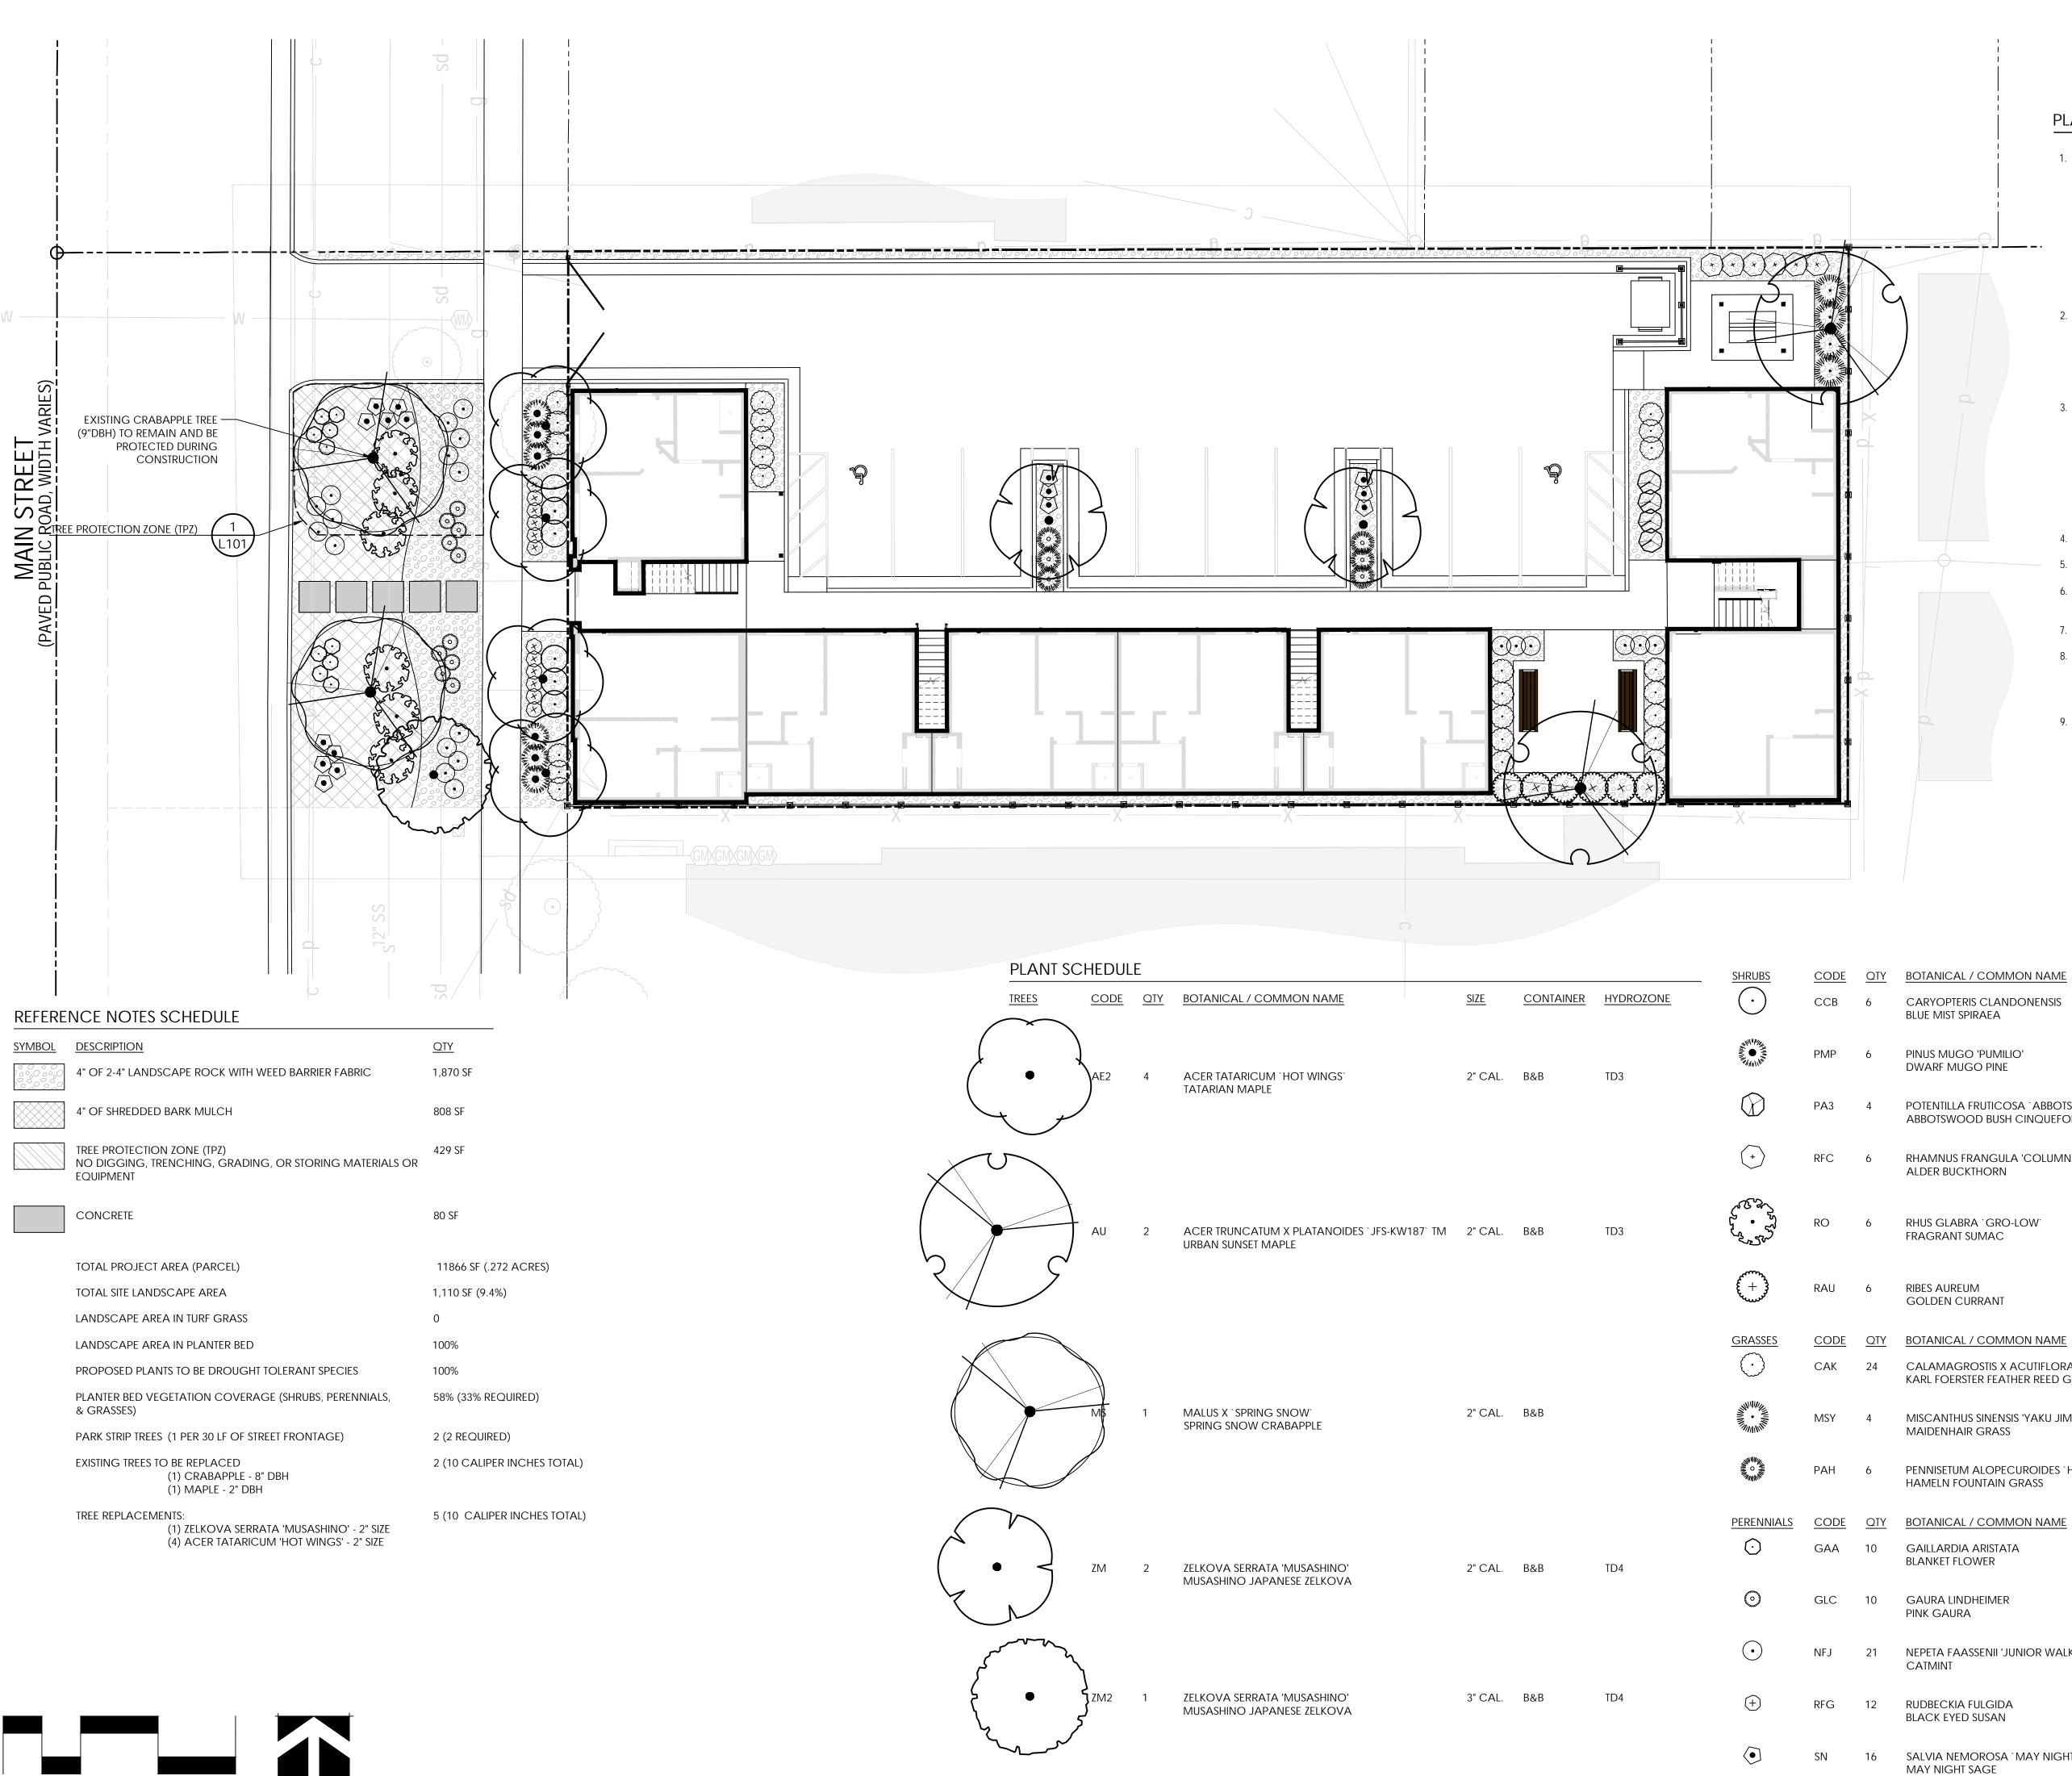

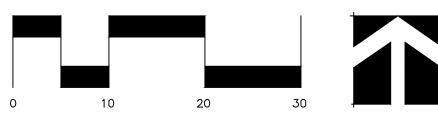

PLANTING NOTES

- 1. CONTRACTOR SHALL BE RESPONSIBLE FOR BECOMING AWARE OF ALL RELATED EXISTING CONDITIONS, UTILITIES, PIPES, AND STRUCTURES, ETC. PRIOR TO BIDDING AND CONSTRUCTION. THE CONTRACTOR SHALL BE RESPONSIBLE FOR CONTACTING ALL UTILITY COMPANIES FOR FIELD LOCATION OF ALL UNDERGROUND UTILITY LINES, INCLUDING DEPTHS, PRIOR TO ANY EXCAVATION. CONTRACTOR SHALL TAKE SOLE RESPONSIBILITY FOR ANY AND ALL COST OR OTHER LIABILITIES INCURRED DUE TO DAMAGE OF SAID UTILITIES/ STRUCTURES/ETC.
- 2. IF CONFLICTS ARISE BETWEEN SIZE OF AREAS ENCOUNTERED ON SITE AND PLANS, CONTRACTOR IS REQUIRED TO CONTACT OWNER'S REPRESENTATIVE FOR RESOLUTION. FAILURE TO MAKE SUCH CONFLICTS KNOWN TO THE OWNER'S REPRESENTATIVE WILL RESULT IN CONTRACTORS
- LIABILITY TO RELOCATE THE MATERIALS. 3. IT IS THE CONTRACTOR'S RESPONSIBILITY TO FURNISH ALL PLANT MATERIALS FREE OF PESTS OR PLANT DISEASES AND HAVE NATURAL FULL SHAPES. PRE-SELECTED OR "TAGGED" MATERIAL MUST BE INSPECTED BY THE CONTRACTOR AND CERTIFIED PEST AND DISEASE FREE, IT IS THE CONTRACTOR'S OBLIGATION TO MAINTAIN AND WARRANTY ALL PLANT MATERIALS PER THE SPECIFICATIONS. ALL PLANTS SHALL BE SUBJECT TO OWNER'S APPROVAL PRIOR TO INSTALLATION. 4. PROVIDE MATCHING SIZES AND FORMS FOR EACH
- SPECIES OF TREES. CONTRACTOR TO REMOVE TREE STAKES AT END OF 5.
- GUARANTEE PERIOD. 6. CONTRACTOR TO PRUNE TREES AS DIRECTED BY
- LANDSCAPE ARCHITECT FOR PROPER SHAPING OF TREES. 7. REMOVE ALL TAGS, TIES AND FLAGGING FROM ALL
- PLANT MATERIAL. 8. 8. MULCH: AFTER COMPLETION OF ALL PLANTING,
- ALL IRRIGATED NON-GRASS AREAS SHALL BE COVERED WITH A MINIMUM LAYER OF FOUR (4) INCHES OF MULCH. NON-POROUS MATERIAL SHALL NOT BE PLACED UNDER THE MULCH.
- 9. ALL LAWN/TURF AREAS TO RECEIVE 4" OF TOPSOIL PRIOR TO LAYING SOD. ALL SHRUB/PERENNIAL PLANTING AREAS TO RECEIVE 12" OF TOPSOIL PRIOR TO PLANTING UNLESS OTHERWISE INDICATED.



Architecture

Architecture Interior Design Landscape Architecture Land Planning Construction Management

> 7927 High Point Parkway, Suite 300 Sandy, UT 84094 Ph: 801.269.0055 Fax: 801.269.1425 www.thinkaec.com

The designs shown and described herein including all technical drawings, graphic representation & models thereof, are proprietary & can not be copied, duplicated, or commercially exploited in whole or in part without the sole and express written permission from ASWN+JSA Architects, Inc.

These drawings are available for limited review and evaluation by clients, consultants, contractors, government agencies, vendors, and office personnel only in accordance with this notice.


IBS	CODE	<u>QTY</u>	BOTANICAL / COMMON NAME	SIZE	FIELD2
)	ССВ	6	CARYOPTERIS CLANDONENSIS BLUE MIST SPIRAEA	5 GAL.	SD2
	PMP	6	PINUS MUGO 'PUMILIO' DWARF MUGO PINE	5 GAL.	SE2
)	PA3	4	Potentilla fruticosa `Abbotswood` Abbotswood bush cinquefoil	5 GAL.	SD2
\rangle	RFC	6	RHAMNUS FRANGULA 'COLUMNARIS' ALDER BUCKTHORN	5 GAL.	SD3
J. J	RO	6	RHUS GLABRA `GRO-LOW` FRAGRANT SUMAC	5 GAL.	GV1
200 100 100 100 100 100 100 100 100 100	RAU	6	RIBES AUREUM GOLDEN CURRANT	5 GAL.	SD2
<u>SSES</u>	CODE	<u>QTY</u>	BOTANICAL / COMMON NAME	<u>SIZE</u>	FIELD2
\rangle	САК	24	CALAMAGROSTIS X ACUTIFLORA `KARL FOERSTER` KARL FOERSTER FEATHER REED GRASS	1 GAL.	TW2
	MSY	4	MISCANTHUS SINENSIS 'YAKU JIMA' MAIDENHAIR GRASS	1 GAL.	TW2
	РАН	6	PENNISETUM ALOPECUROIDES `HAMELN` HAMELN FOUNTAIN GRASS	1 GAL.	TW2
NNIALS	CODE	<u>QTY</u>	BOTANICAL / COMMON NAME	<u>SIZE</u>	FIELD2
)	GAA	10	GAILLARDIA ARISTATA BLANKET FLOWER	1 GAL.	P1
)	GLC	10	gaura lindheimer Pink gaura	1 GAL.	P1
)	NFJ	21	NEPETA FAASSENII 'JUNIOR WALKER' CATMINT	1 GAL.	P2
)	RFG	12	RUDBECKIA FULGIDA BLACK EYED SUSAN	1 GAL.	P2
]	SN	16	Salvia Nemorosa `may Night` May Night Sage	1 GAL.	P2



PROJECT N	NO.	22038
DATE:	DEC.	12, 2022
REVISIONS :		

SHEET TITLE: OVERALL LANDSCAPE PLAN SHEET NUMBER: L100

LANDSCAPE

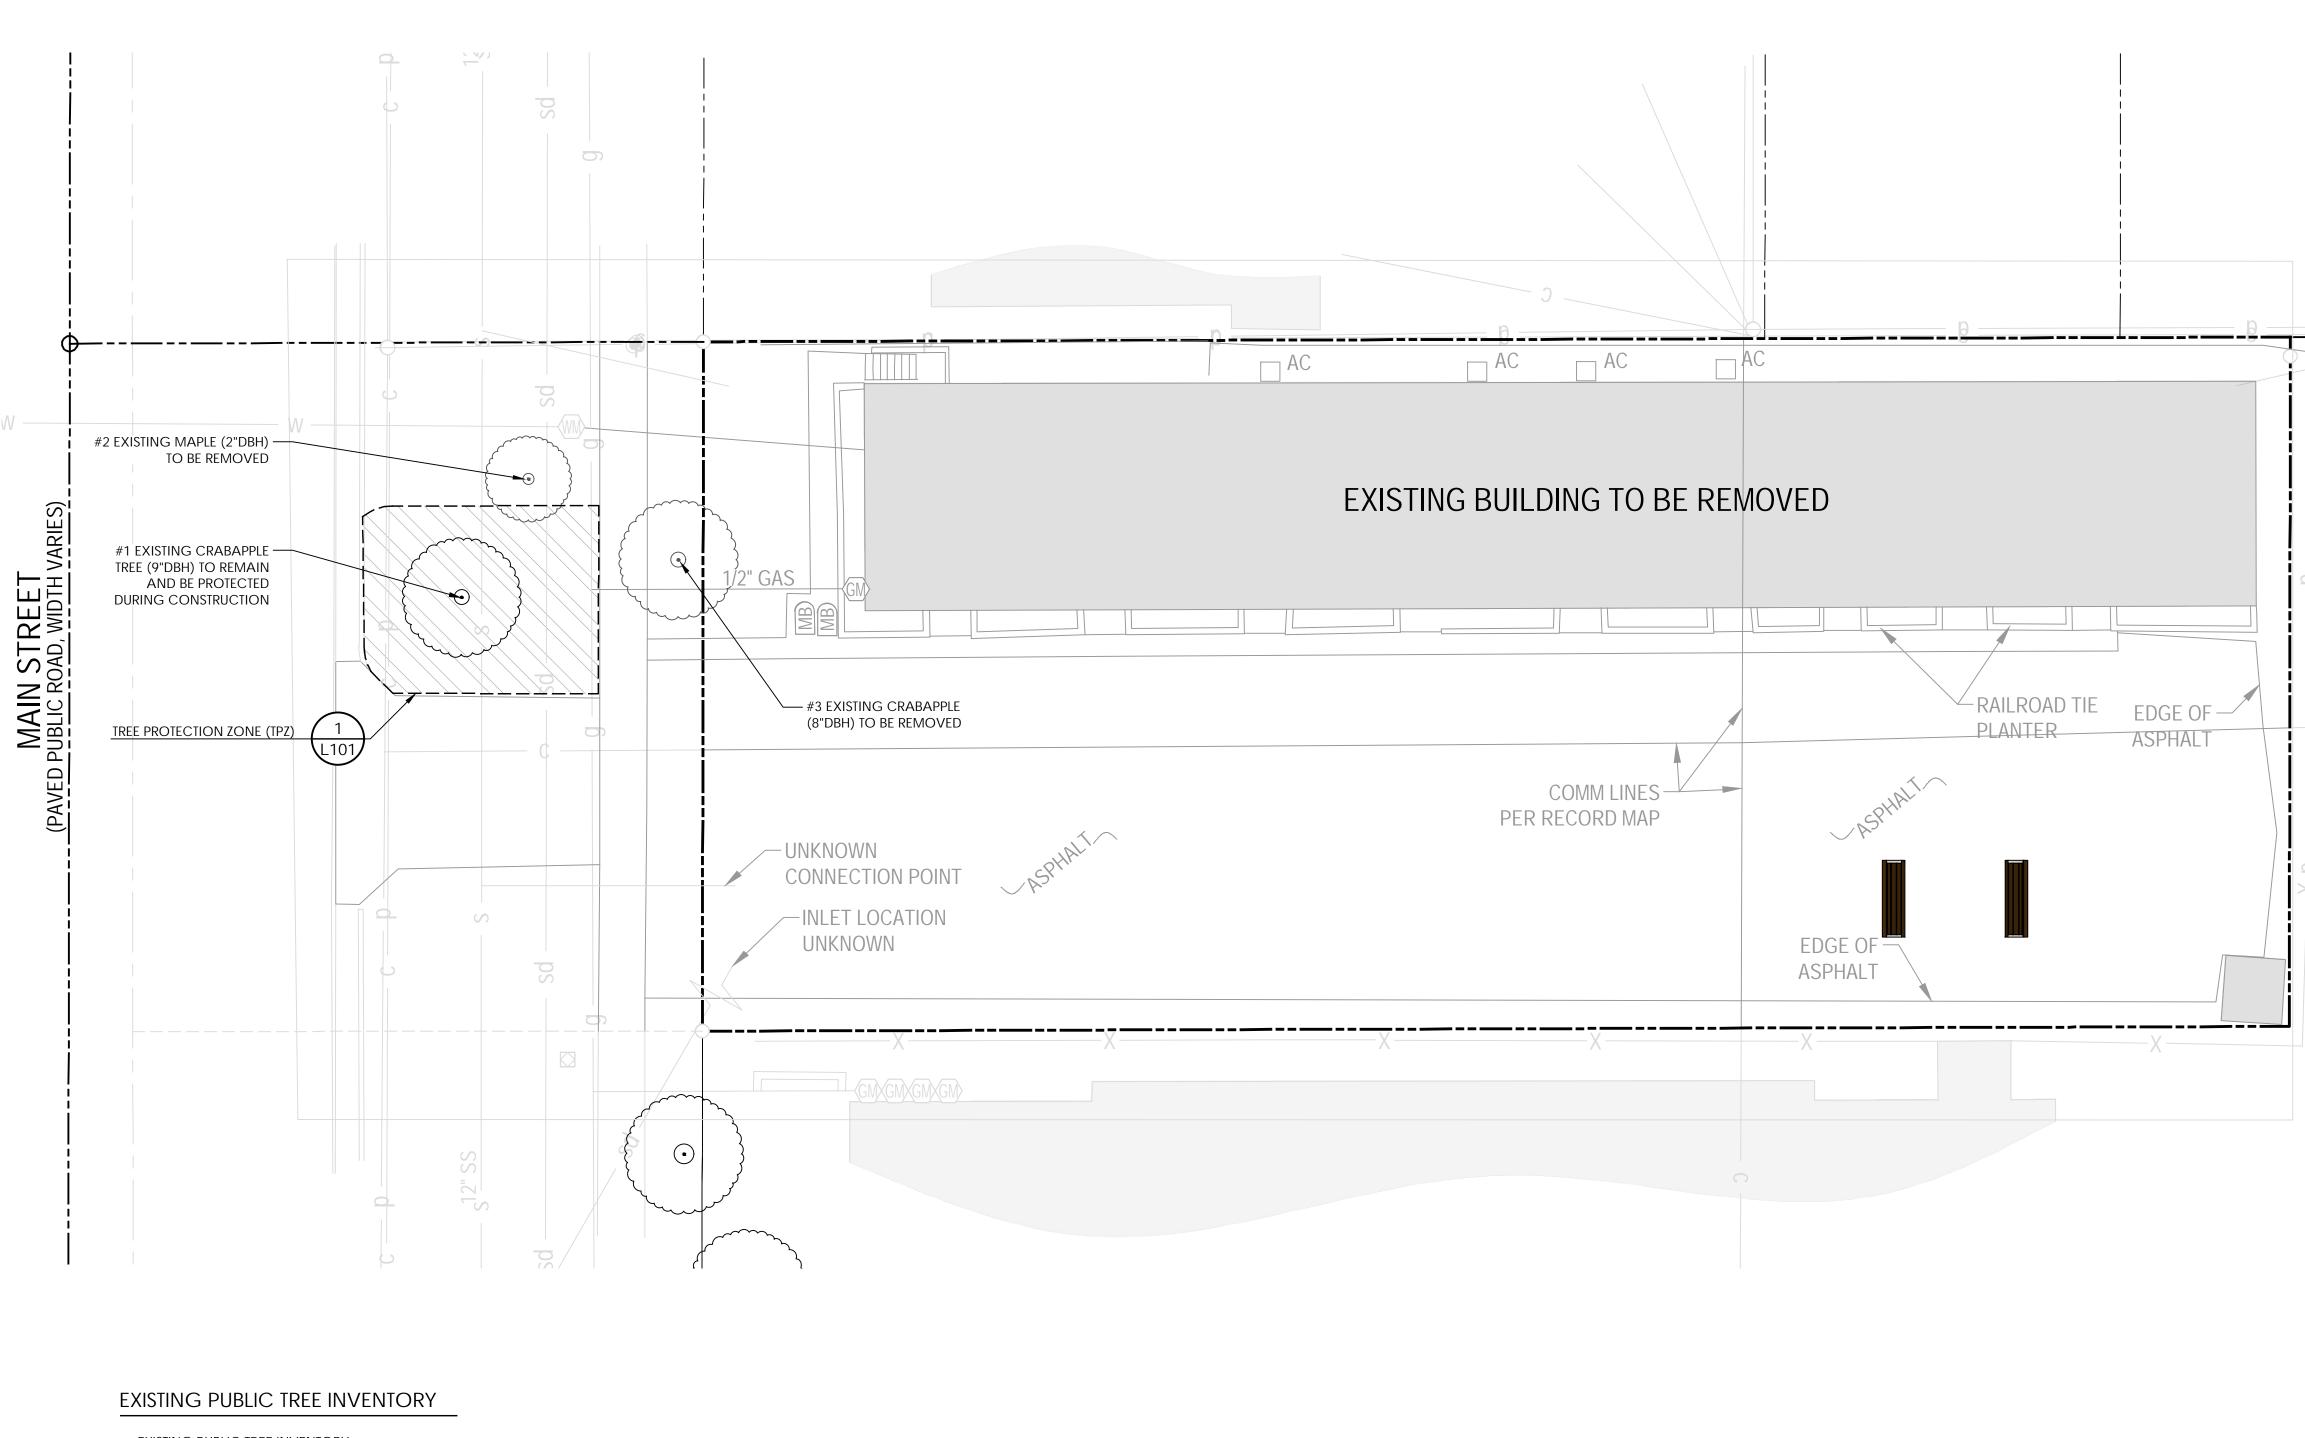

SYM.	SPECIES	SIZE
#1	CRABAPPLE	9" DBH
#2	MAPLE	2" DBH

DESCRIPTION

MATURE TREE, GOOD CONDITION, TO REMAIN


#2	MAPLE	2" DBH	
#3	CRABAPPLE	8"DBH	


SMALL TREE, MODERATE CONDITION, TO BE REMOVED FOR PROPOSED DEVELOPMENT MATURE TREE, GOOD CONDITION, TO BE REMOVED FOR PROPOSED DEVELOPMENT

NO EXISTING PRIVATE PROPERTY


NOTES

- 1. FOR EXISTING AND PROPOSED UTILITIES, SEE UTILITY
- PLAN, CIVIL DRAWINGS 2. FOR PROPOSED IMPROVEMENTS, SEE LANDSCAPE
- PLAN. 3. TREE REMOVAL OR TREE PLANTING IN THE PUBLIC
- WAY REQUIRES APPROVAL FROM SALT LAKE CITY URBAN FORESTRY. 4. TREE PROTECTION ZONE (TPZ) TO BE DEFINED BY 6' TALL CHAIN LINK FENCING. FENCING TO BE FREE STANDING, NO POSTS DRIVEN INTO THE ROOT SYSTEM. SIGNAGE SHALL BE POSTED ON THE LINEAR SPAN OF THE FENCE PER SALT LAKE CITY URBAN FORESTRY STANDARDS. THE TPZ FENCING AND SIGNAGE WILL REMAIN IN PLACE UNTIL PROJECT COMPLETION OR UNTIL SALT LAKE CITY URBAN FORESTRY HAS PROVIDED WRITTEN AUTHORIZATION
- ALLOWING REMOVAL OF FENCING. 5. NO DIGGING, TRENCHING, GRADING, SILTATION, MASONRY SET-UP, OR STORING OF MATERIALS OR EQUIPMENT IN TPZ.

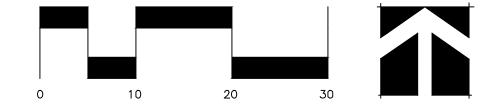

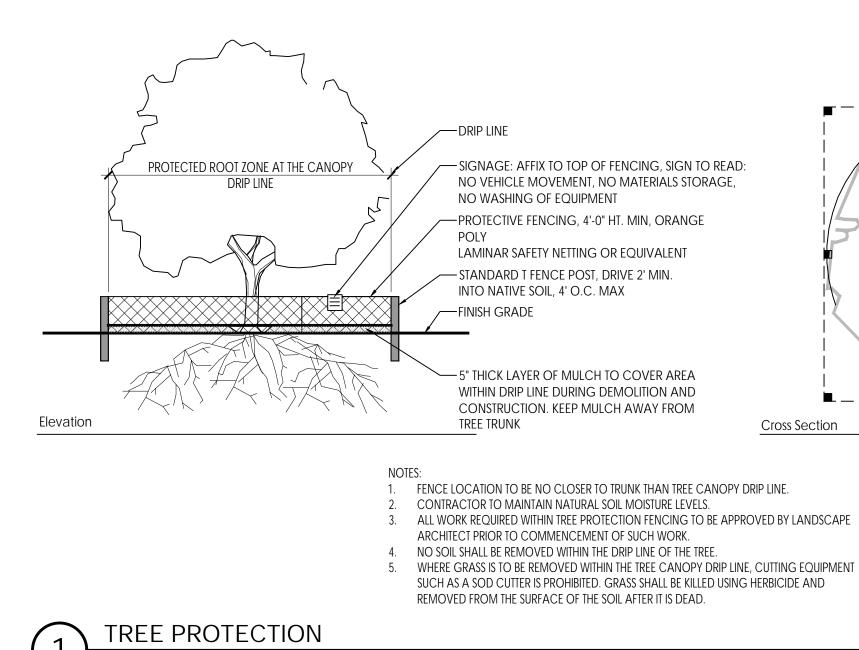

NOT TO SCALE

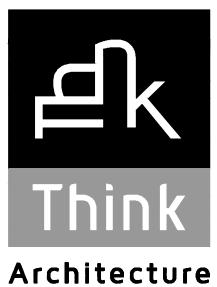

Architecture Interior Design Landscape Architecture Land Planning Construction Management

> 7927 High Point Parkway, Suite 300 Sandy, UT 84094 Ph: 801.269.0055 Fax: 801.269.1425 www.thinkaec.com

The designs shown and described herein including all technical drawings, graphic representation & models thereof, are proprietary & can not be copied, duplicated, or commercially exploited in whole or in part without the sole and express written permission from ASWN+JSA Architects, Inc.

These drawings are available for limited review and evaluation by clients, consultants, contractors, government agencies, vendors, and office personnel only in accordance with this notice.



22038


DEC. 12, 2022

PROJECT NO

DATE:

REVISIONS:

SHEET TITLE:

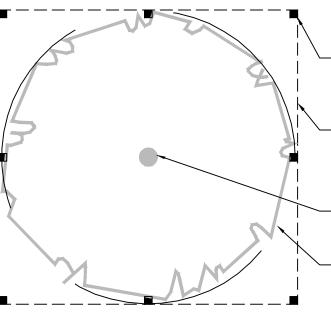

STANDARD T FENCE POST, DRIVE 2' MIN. INTO NATIVE SOIL, 4' O.C. MAX

MIN. ORANGE POLY LAMINAR SAFETY NETTING OR EQUIVALENT ------EXISTING TREE

TREE CANOPY DRIP LINE


Cross Section



TREE PROTECTION &


REMOVAL PLAN

T-SI-DMO-02

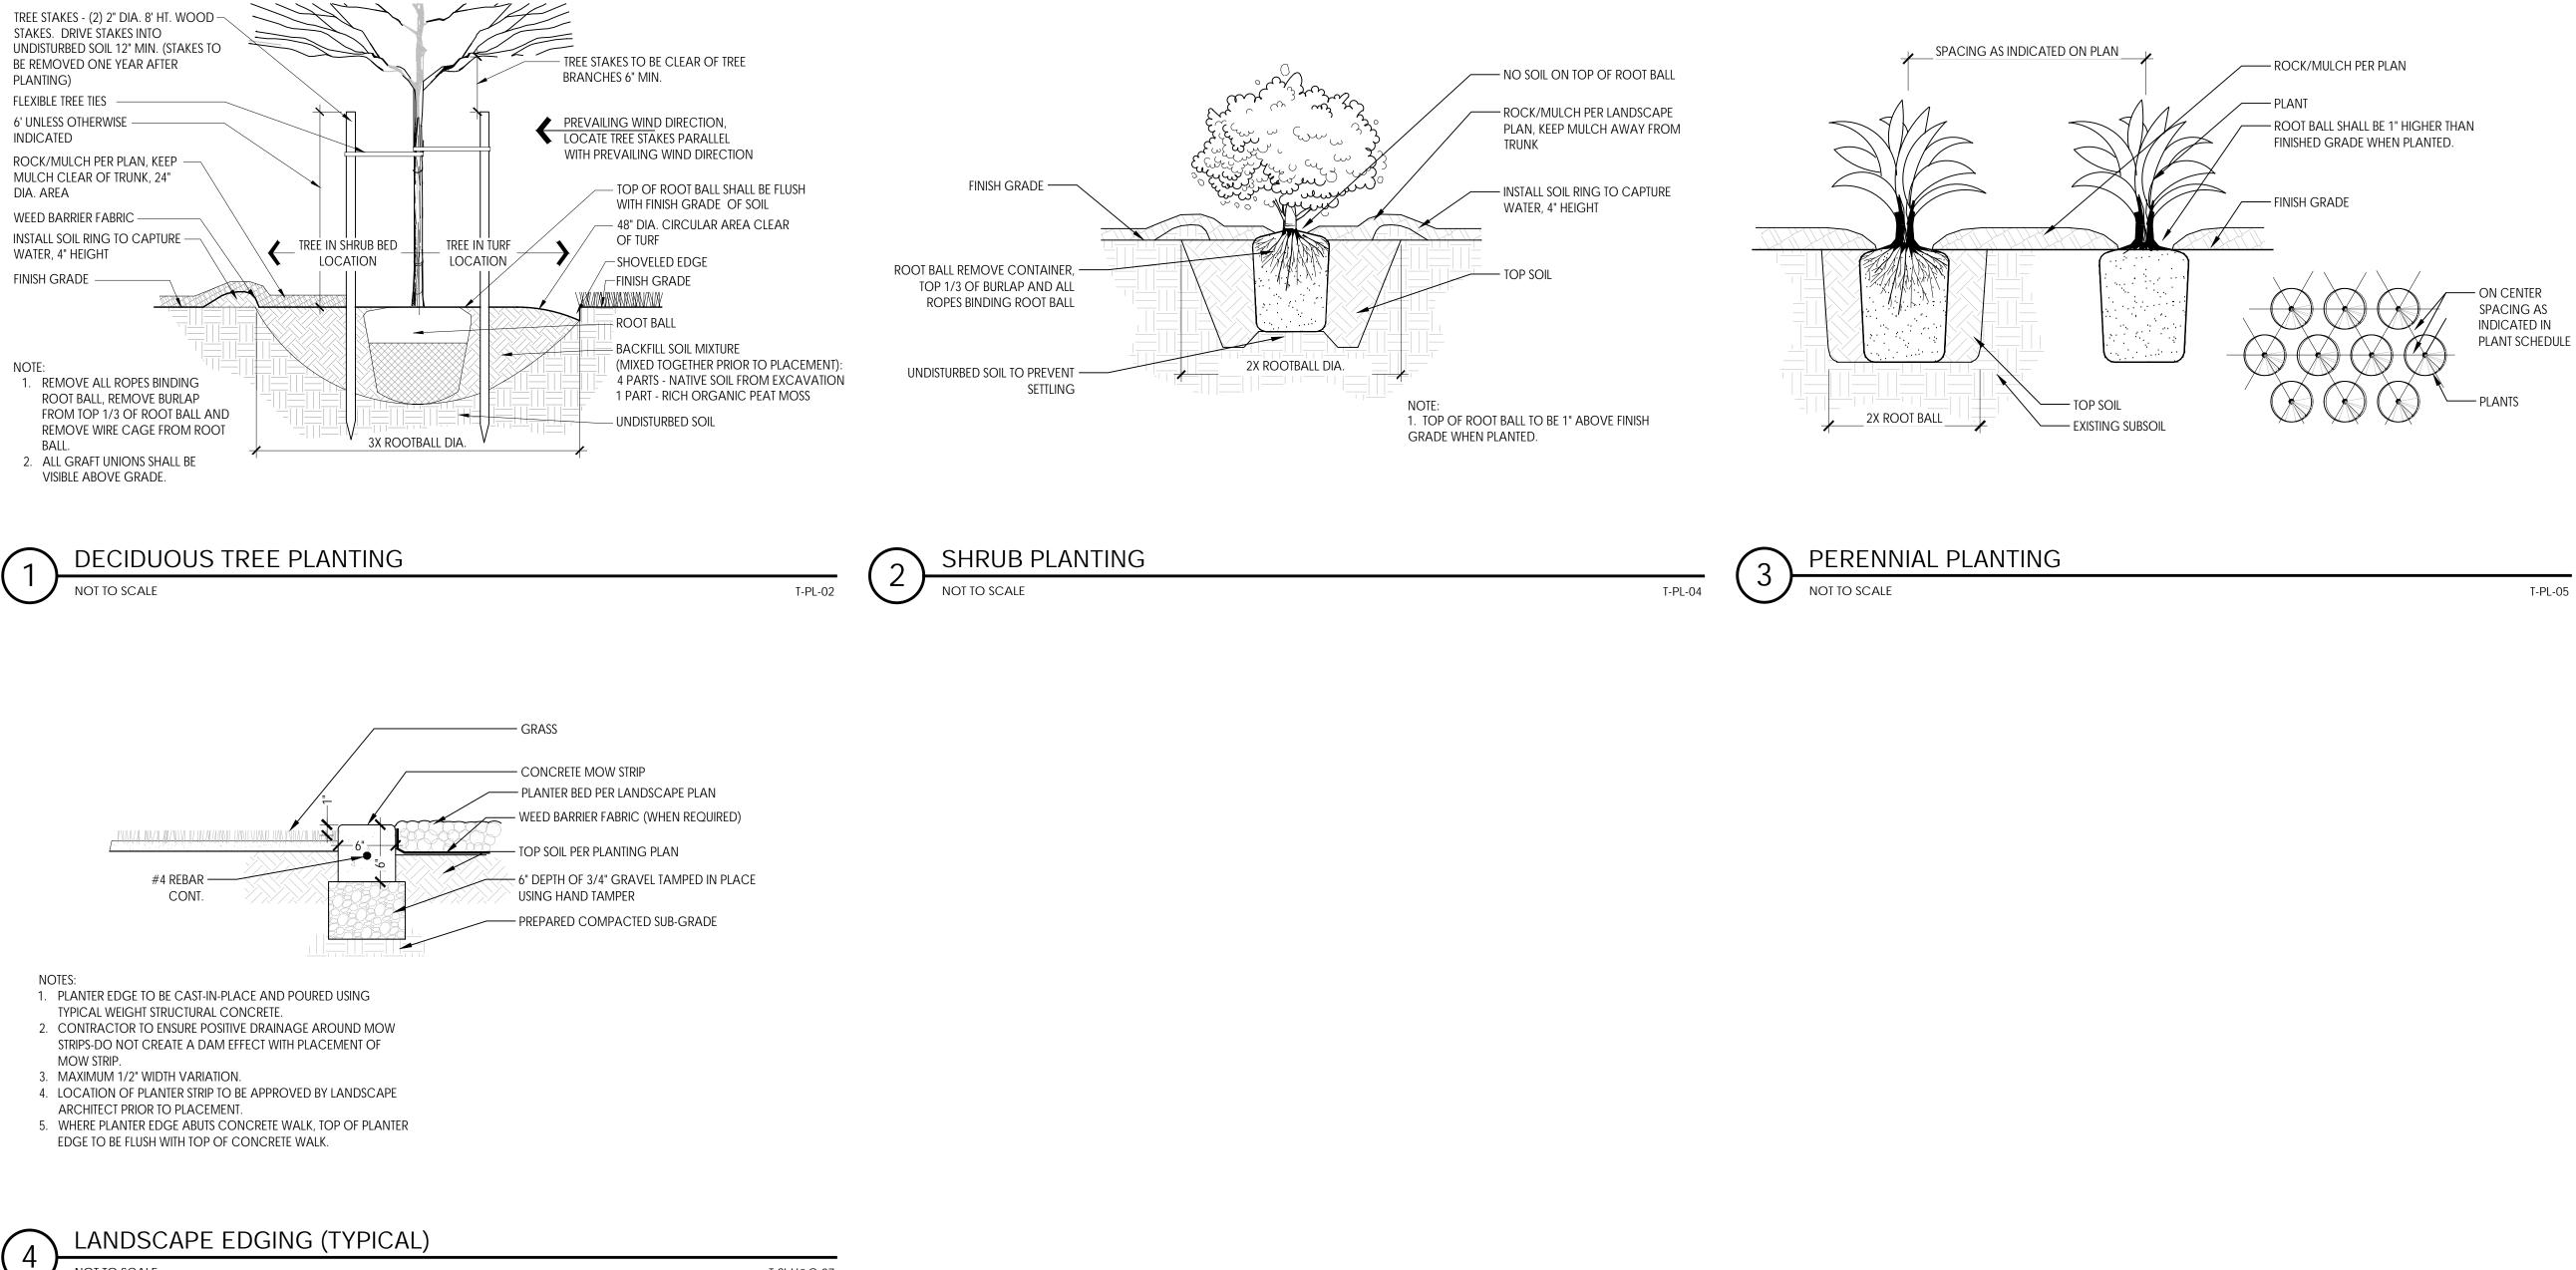

NOT TO SCALE

T-SI-H&C-07

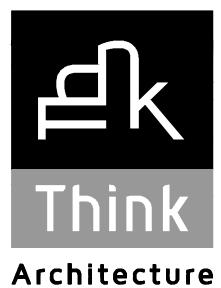

Architecture Interior Design Landscape Architecture Land Planning Construction Management

> 7927 High Point Parkway, Suite 300 Sandy, UT 84094 Ph: 801.269.0055 Fax: 801.269.1425 www.thinkaec.com

The designs shown and described herein including all technical drawings, graphic representation & models thereof, are proprietary & can not be copied, duplicated, or commercially exploited in whole or in part without the sole and express written permission from ASWN+JSA Architects, Inc.


These drawings are available for limited review and evaluation by clients, consultants, contractors, government agencies, vendors, and office personnel only in accordance with this notice.


ALLIANCE HOUSE 1805 SOUTH MAIN STREET SALT LAKE CITY, UT 84115

PROJECT N	22038	
DATE:	DEC.	12, 2022
REVISIONS:		

OVERALL LANDSCAPE PLAN SHEET NUMBER: L100 LANDSCAPE

SHEET TITLE:

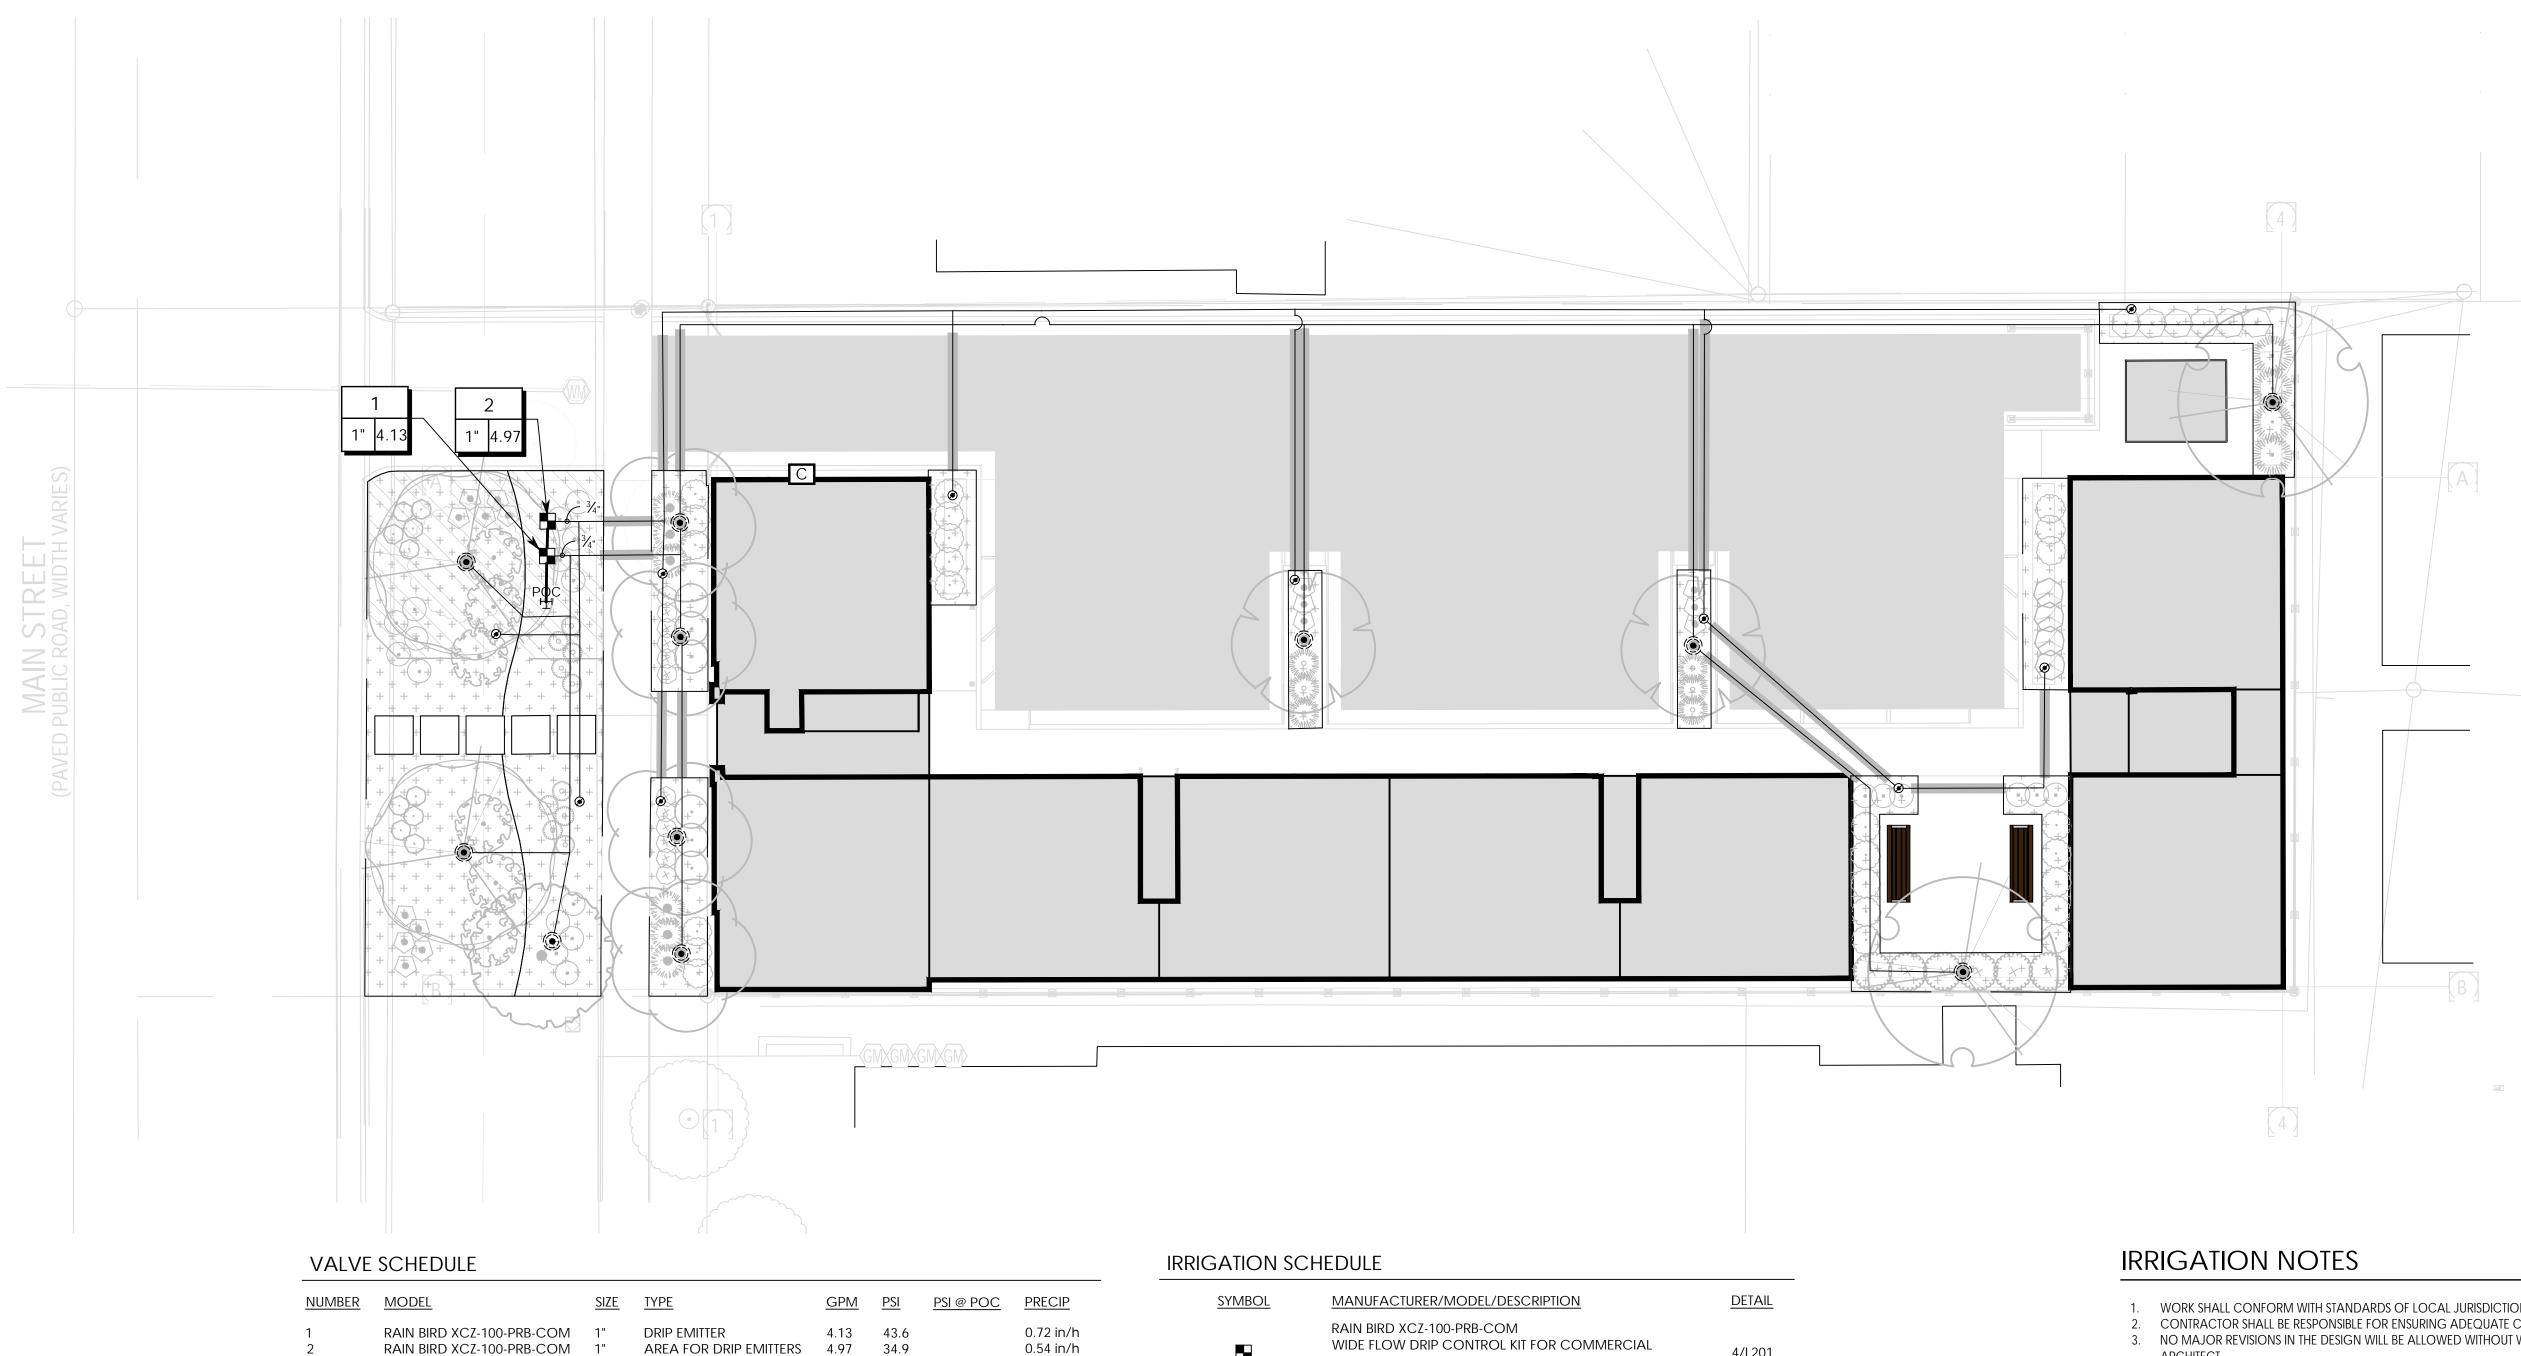

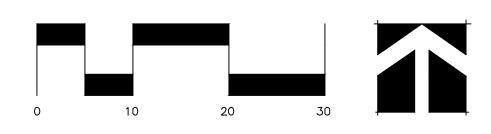

IRRIGATION SCHEDULE	

<u>209</u>	PRECIP	SYMBOL	MANUFACTURER/MODEL/DESCRIPTION	DETAIL	1	. \	WO
	0.72 in/h 0.54 in/h		RAIN BIRD XCZ-100-PRB-COM WIDE FLOW DRIP CONTROL KIT FOR COMMERCIAL APPLICATIONS. 1" BALL VALVE WITH 1" PESB VALVE AND 1" PRESSURE REGULATING 40PSI QUICK-CHECK BASKET FILTER. 0.3GPM TO 20GPM.	4/L201	3	8. N 4 4. ľ	INC
		۲	PIPE TRANSITION POINT ABOVE GRADE PIPE TRANSITION POINT FROM PVC LATERAL TO DRIP TUBING WITH RISER TO ABOVE GRADE INSTALLATION.		J	5 5 [sha Slee Dep
		۲	TREE DRIP RING RAINBIRD XFD-09-12 DRIP LINE FORMED INTO 2 CIRCLES - ONE 12" RADIUS, ONE 36" RADIUS.	6/L201	6	\ [co Whi Dim Arc
		+ + + + + + + + + + + + + + + + + + +	AREA TO RECEIVE DRIP EMITTERS RAIN BIRD XB-PC INSTALL (1) DRIP RING WITH INDICATOR EMITTER PER DETAIL AT EVERY TREE PLANTED IN PLANTER BED AREAS. INSTALL THE FOLLOWING EMITTERS FOR ALL OTHER PLANTS: Emitter Notes:	5/L201	7	(. 1 (PER ORE 120 CO CO ELE(
			1.0 GPH emitters (2 assigned to each 1 gal. plant) 2.0 GPH emitters (2 assigned to each 5 gal. plant)		8	3. T (THE CO OTH
		SYMBOL	MANUFACTURER/MODEL/DESCRIPTION	DETAIL	9). Т Т	the The
		C POC ビ	CONTROLLER SMART CONTROLLER WITH FLOW SENSOR. WALL MOUNT, CONTRACTOR TO PROVIDE POWER TO CONTROLLER POINT OF CONNECTION 1"		1	0. ([[E	Pos Gu/ Def Dan Eql
			IRRIGATION LATERAL LINE: PVC SCHEDULE 40	2/L201	1	1. 	INST INST
			IRRIGATION MAINLINE: PVC SCHEDULE 40	2/L201	1	2. T	resi The Val
			PIPE SLEEVE: PVC SCHEDULE 40	3/L201	1	E	for Be S Refi
		# •	Valve Callout Valve Number			T 4. E	to e Estii
		#" #●	Valve Flow		1	5. F	lan Pric Co
			——— Valve Size			I	INC SCF
					1	<u>~</u> /	AT 1

NORK SHALL CONFORM WITH STANDARDS OF LOCAL JURISDICTION.

CONTRACTOR SHALL BE RESPONSIBLE FOR ENSURING ADEQUATE COVERAGE OF ALL IRRIGATED AREAS. NO MAJOR REVISIONS IN THE DESIGN WILL BE ALLOWED WITHOUT WRITTEN APPROVAL FROM THE LANDSCAPE ARCHITECT

IT IS THE RESPONSIBILITY OF THE CONTRACTOR TO BECOME FAMILIAR WITH CONDITIONS OF THE SITE

NCLUDING GRADES, LOCATIONS OF WALKS, STRUCTURES AND UTILITIES. THE CONTRACTOR SHALL REPAIR OR REPLACE ALL ITEMS DAMAGED DURING CONSTRUCTION. CONTRACTOR SHALL COORDINATE WORK WITH OTHER CONTRACTORS FOR THE LOCATION AND INSTALLATION OF PIPE SLEEVES AND LATERAL LINES THROUGH WALLS, AND UNDER HARD SURFACES. SLEEVES INSTALLED AT IMPROPER DEPTHS WILL BE RE-INSTALLED BY BORING METHODS.

CONTRACTOR SHALL NOT WILLFULLY INSTALL THE IRRIGATION SYSTEM COMPONENTS SHOWN ON THE PLAN NHEN FIELD CONDITIONS, INCLUDING UNKNOWN OBSTRUCTIONS, DIFFERENCES IN GRADE AND AREA DIMENSIONS EXIST THAT ARE NOT INCLUDED IN THE DESIGN. CONTRACTOR TO NOTIFY THE LANDSCAPE ARCHITECT WHEN SUCH OBSTRUCTIONS OR DIFFERENCES OCCUR. IN THE EVENT THIS NOTIFICATION IS NOT PERFORMED, THE CONTRACTOR SHALL ASSUME FULL RESPONSIBILITY FOR ANY REVISIONS OR CHANGE ORDERS.

120V AC ELECTRICAL POWER SOURCE AT THE CONTROLLER LOCATION SHALL BE PROVIDED BY OTHERS, COORDINATE WITH GENERAL CONTRACTOR. THE IRRIGATION CONTRACTOR SHALL MAKE THE FINAL CONNECTION FROM THE ELECTRICAL SOURCE TO THE CONTROLLER. REFER TO THE SPECIFICATIONS FOR ELECTRICAL REQUIREMENTS.

THE IRRIGATION CONTRACTOR SHALL ADJUST VALVES, FLUSH AND ADJUST IRRIGATION HEADS FOR OPTIMUM COVERAGE WITH MINIMAL OVERSPRAY ONTO HARD SURFACES AND ELIMINATE SPRAY ON BUILDINGS AND OTHER VERTICAL SURFACES.

THE LANDSCAPE ARCHITECT HAS THE RIGHT TO REFUSE MATERIAL OR WORK WHICH DOES NOT CONFORM TO THE CONSTRUCTION DOCUMENTS. REJECTED WORK SHALL BE BE REMOVED OR CORRECTED AS SOON AS POSSIBLE A THE CONTRACTOR'S EXPENSE.

GUARANTEE: ALL WORK SHALL BE GUARANTEED FOR ONE YEAR FROM DATE OF ACCEPTANCE AGAINST ALL DEFECTS IN MATERIAL, EQUIPMENT, AND WORKMANSHIP. GUARANTEE SHALL ALSO COVER REPAIR FOR DAMAGE TO ANY PART OF THE PROJECT PROPERTY RESULTING FROM LEAKS OR OTHER DEFECTS IN MATERIAL, Equipment or Workmanship, to the satisfaction of the owner. Repairs, if required, shall be COMPLETED PROMPTLY AND AT NO COST TO THE OWNER.

NSTALL CONTROLLERS AND REQUIRED CONTROLLER GROUNDING AS PER MANUFACTURER'S WRITTEN NSTRUCTIONS. COORDINATE LOCATION WITH LANDSCAPE ARCHITECT. IRRIGATION CONTRACTOR IS RESPONSIBLE FOR INSTALLING CONDUITS AND WIRING FROM VALVES TO CONTROLLERS.

THE IRRIGATION PLAN IS DRAWN DIAGRAMMATICALLY FOR CLARITY. IT IS THE INTENT TO HAVE ALL PIPING, VALVES, AND WIRING TO BE LOCATED IN PLANTING AREAS, WITH THE EXCEPTION OF LOCATIONS REQUIRED OR HARD SURFACE CROSSINGS. ADDITIONAL SLEEVES WILL BE REQUIRED. ALL IRRIGATION SLEEVES MAY NOT BE SHOWN.


REFER TO PLANTING PLAN FOR COORDINATING HEAD LOCATIONS WITH TREE LOCATIONS. IRRIGATION HEADS TO BE LOCATED TO MINIMIZE TREE CREATED SPRAY SHADOW. ESTIMATED STATIC WATER PRESSURE AT POINT OF CONNECTION: 80 PSI. CONTRACTOR IS TO NOTIFY

LANDSCAPE ARCHITECT IN WRITING IF STATIC PRESSURE IS LESS. PRIOR TO ACCEPTANCE OF WORK AND AS PART OF THE IRRIGATION PUNCH LIST THE CONTRACTOR SHALL

CONDUCT A MEETING WITH THE OWNER TO DEMONSTRATE THE OPERATION OF THE ENTIRE IRRIGATION SYSTEM NCLUDING WINTERIZATION AND START-UP PROCEDURES AND PROVIDE A RECOMMENDED IRRIGATION Schedule. Remote operating equipment, if any, shall be given to owner at this time. 16. ALL VALVE BOXES TO BE SUPPORTED WITH BRICK / CONCRETE MASONRY UNIT.

17. LOCATE IRRIGATION CONTROL VALVES IN LANDSCAPE AREAS, ADJACENT TO WALKS OR CURBS. 18. IRRIGATION SYSTEM WIRING LOCATED APART FROM IRRIGATION MAIN LINE TO BE PLACED IN GRAY PVC SLEEVES OF ADEQUATE SIZE.

19. CONTRACTOR TO CONDUCT A SYSTEM PRESSURE TEST IN THE PRESENCE OF THE LANDSCAPE ARCHITECT PRIOR TO BACKFILLING MAIN LINE TRENCHES. CONTRACTOR TO NOTIFY THE LANDSCAPE ARCHITECT TWO WORKING DAYS MINIMUM PRIOR TO CONDUCTING THE SYSTEM PRESSURE TEST. PRESSURE TEST MAIN LINE AND ALL VALVES INSTALLED AT 100 PSI FOR 2 HOURS MINIMUM.

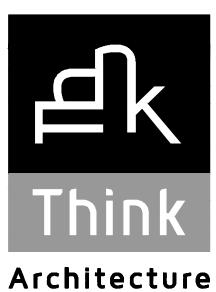

Architecture Interior Design Landscape Architecture Land Planning Construction Management

> 7927 High Point Parkway, Suite 300 Sandy, UT 84094 Ph: 801.269.0055 Fax: 801.269.1425 www.thinkaec.com

The designs shown and described herein including all technical drawings, graphic representation & models thereof, are proprietary & can not be copied, duplicated, or commercially exploited in whole or in part without the sole and express written permission from ASWN+JSA Architects, Inc.

These drawings are available for limited review and evaluation by clients, consultants, contractors, government agencies, vendors, and office personnel only in accordance with this notice.


ALLIANCE HOUSE 1805 SOUTH MAIN STREET SALT LAKE CITY, UT 84115


PROJECT NO.		22038
DATE:	DEC.	12, 2022
REVISIONS :		


SHEET TITLE: **IRRIGATION PLAN**


SHEET NUMBER:



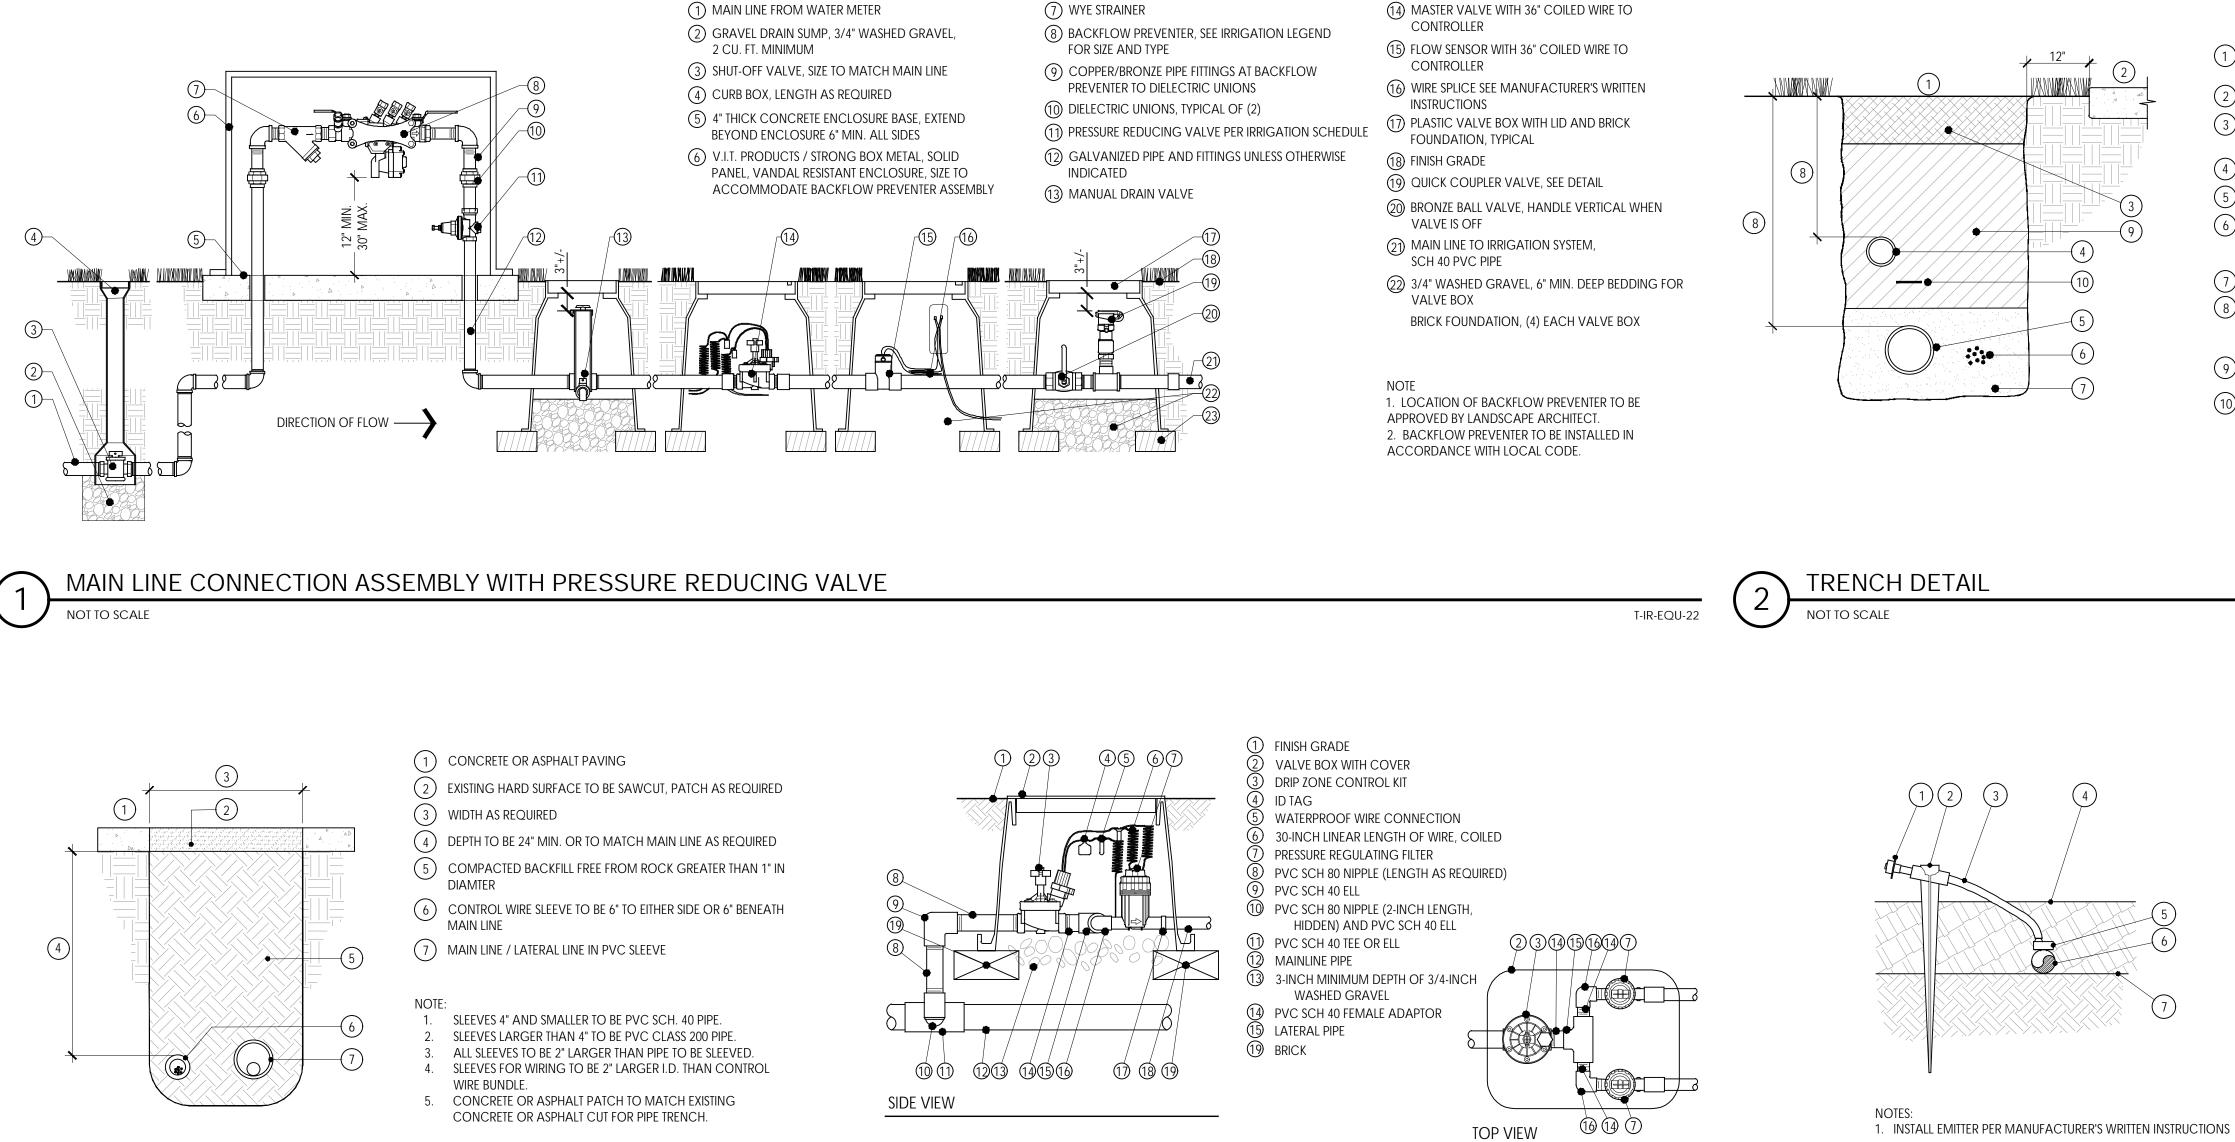

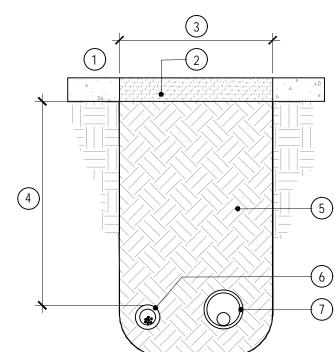

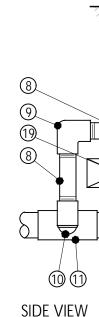

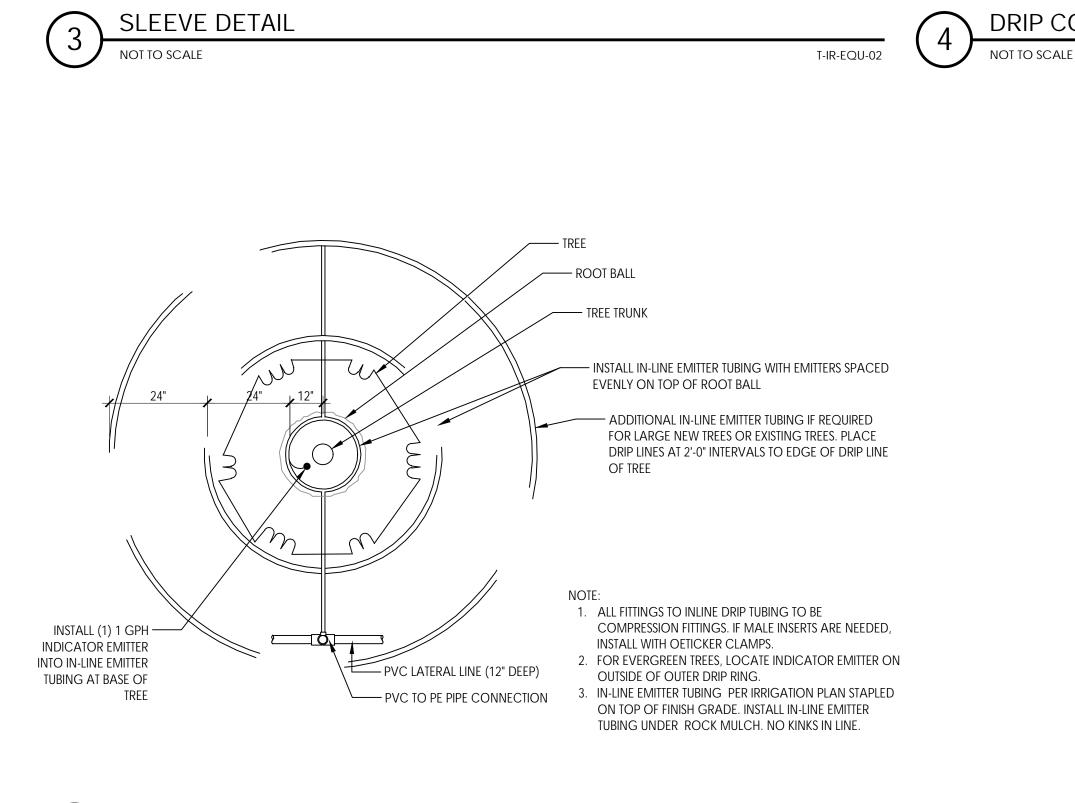

TREE IN-LINE EMITTER TUBING LAYOUT (PLANTER AREAS)

6

DRIP CONTROL ZONE KIT (UP TO 1.5")

T-IR-VAL-06


DRIP EMITTER WITH DISTRIBUTION TUBING NOT TO SCALE

(1) IF LAWN IS EXISTING, REPLACE SOD AS PER OWNER'S SPECIFICATIONS (2) ADJACENT HARD SURFACE 3 TOPSOIL FREE FROM ROCKS GREATER THAN 1" DIAMETER. LAYER THICKNESS AS INDICATED IN PLANTING NOTES (4) NON-PRESSURE LATERAL LINE 5 PRESSURE MAIN LINE (6) DIRECT BURIAL, LOW VOLTAGE CONTROL WIRES; TAPE AND BUNDLE AT 10' O.C. PLACE 6" EITHER SIDE, OR 6" BELOW Main Line Pipe. (7) MORTAR SAND BEDDING 2" BELOW AND ABOVE PIPE (8) PIPE DEPTHS: MAIN LINE: 24 - 30" COVER LATERAL LINE: 8 - 16" COVER (9) BACKFILL SOIL FREE FROM ROCKS GREATER THAN 1" DIAMETER. (10) DECTABLE WARNING TAPE AT MAIN LINE

T-IR-EQU-01

- 1) DIFFUSER BUG CAP
- 2 TUBING STAKE
- 3 DISTRIBUTION TUBING
- 4 TOP OF MULCH
- (5) SINGLE-OUTLET BARB INLET X BARB OUTLET EMITTER
- (6) 1/2" POLYETHYLENE TUBING
- 7 FINISH GRADE

T-IR-DRI-02

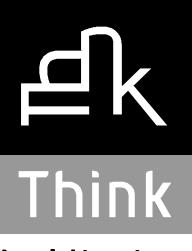

Architecture

Architecture Interior Design Landscape Architecture Land Planning Construction Management

> 7927 High Point Parkway, Suite 300 Sandy, UT 84094 Ph: 801.269.0055 Fax: 801.269.1425 www.thinkaec.com

The designs shown and described herein including all technical drawings, graphic representation & models thereof, are proprietary & can not be copied, duplicated, or commercially exploited in whole or in part without the sole and express written permission from ASWN+JSA Architects, Inc.

These drawings are available for limited review and evaluation by clients, consultants, contractors, government agencies, vendors, and office personnel only in accordance with this notice.


ALLIANCE HOUSE 1805 SOUTH MAIN STREET SALT LAKE CITY, UT 84115

PROJECT NO.		22038
DATE:	DEC.	12, 2022
REVISIONS:		

SHEET TITLE: **IRRIGATION DETAILS**

SHEET NUMBER:



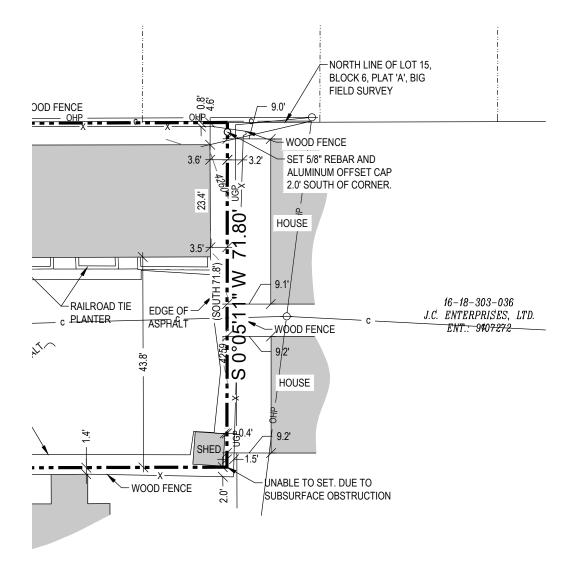

• 0.0 • 0.1 • 0.1 • 0.2 • 0.3 • 0.5 • 0.7 • 0.0 • 0.0 • 0.0 • 0.0 • 0.0 • 0.0 • 0.0 • 0.0 • 0.0 • 0.1 • 0.4 • 0. • 1.4 • 0.9 • 0.7 • 1.7 • 1.5 WS1 WS1 WS1/ WS1 • 0.0 • 0.0 • 0.0 • 0.0 • 0.0 • 0.0 • 0.0 • 0.0 • 0.1 • 0.4 • 0 • 0.0 • 0-----WS1 RC1 RC1 RC1 RC1 RC1 WS1 • 0.0 • 0.0 • 0.0 • 0.0 • 0.0 • 0.0 • 0.0 • 0.0 • 0.0 • 0.0 • 0.2 • 0.5 • 0 • 0.0 • 0.0 • 0.0 • 0.0 • 0.0 • 0.0 • 0.0 • 0.0 • 0.0 • 0.0 • 0.0 • 0.0 • 0.0 • 0.0 • 0.0 • 0.1 • 0.3 • 0 • 0.0 • 0.0 • 0.0 • 0.0 • 0.0 • 0.0 • 0.0 • 0.0 • 0.0 • 0.0 • 0.0 • 0.0 • 0.0 • 0.0 • 0.0 • 0.0 • 0.0 • 0.1 • 0.6 • 2 • 0.0 • 0.0 • 0.0 • 0.0 • 0.0 • 0.0 • 0.0 • 0.0 • 0.0 • 0.0 • 0.0 • 0.0 • 0.0 • 0.0 • 0.0 • 0.0 • 0.1 • 0.4 • 0. • 0.0 • 0.0 • 0.0 • 0.0 • 0.0

		CONSTRUCTION NOTES
	LIGHTING FIXTURE SCHEDULE	1. GRID VALUES ARE FOOT-CANDLES AT GROUND LEVEL.
	LIGHTING FIXTORE SCHEDULE Mark Description Manufacturer Model	Wattage Lamp Count
	FFESTOON LIGHTTokistarExibitor BK-24-UBIW-G19-C (EX-MDA-BK)P1Full cut-off pole light, H=16'LithoniaRSX1 LED-P1-30K-R4	2 W LED 51 51 W LED 4
	RC1 Recessed 6" Can light Elite Lighting B6IC-1500L-DIM10-MVOLT-MD-30K-90+-AT WS1 Wall Sconce down light Kuzco BYRON EW3406-3000K	17 W LED 8 9 W LED 15
PROPERTY LINE (TYP)		
	● 0.0 ● 0.0	
0 • 0.0 • 0.0 • 0.0 • 0.0 • 0.0 • 0.0 • 0.0 • 0.0 • 0.0 • 0.0 • 0.0 • 0.0 • 0.0 • 0.0 • 0.0 • 0.0 • 0.0 • 0.0	• 0.0 • 0.0	DATE
	●0.0 ●0.0 ●0.0 ●0.0 ●0.0 ●0.0 ●0.0 ●0.0	DECEMBER 2022
∕ ●0.9 ●1.1 ●1.3 ●1.6 ●: ●2.5 ●3.4 ●3.€ ●3.2 ●2.9 ●2.9 ●2.9 ●2.9 ●3.1 ●3.5 ●3.6 ●2.7 ●2	● 1.7 ● 1.4 ● 1.2 ● 1.0 ● 0.9 ● 0.7 ● 1.2 ● 1.3 ● 0.8 ● ● 0.0 ● 0.0 ● 0.0 ● 0.	
) ●1.0 ●1.2 ●1.4 ●1.7 ●; ●2.8 ●4.1 ●4.4 ●3.6 ●3.2 ●3.0 ●2.9 ●3.1 ●3.5 ●4.2 ●4.4 ●3.1 ●2	• 1.8 • 1.4 • 1.2 • 1.0 • 0.8 • 1.3 • 2.3 • 2.9 • 1.6 ± • 0.0 • 0.0 • 0.	
5 ●1.2 ●1.3 ●1.5 ●1.9 ●: ●3.4 ●5.2 ●5.7 ●4/3 ●3.8 ●3.4 ●3.3 ●3.7 ●4.1 ●5.3 ●5.7 ●3.9 ●2	• 2.0 • 1.6 • 1.4 • 1.3 • 1.8 • 2.7 2.4° • 2.1 • 1.2 • 0.0 • 0.0 • 0.	REVISIONS
● 1.1 ● 1.5 ● 1.8 ● 2.3 ● ↓ 4.4 ● 6.7 ● 7.5 ● 5.4 ● 4.7 ● 4.1 ● 4.0 ● 4.6 ● 5.2 ● 6.8 ● 7.4 ● 5.0 ● 3	• 2.5 • 1.9 • 1.6 • 1.3 • 1.1 • 0.0 • 0.0 • 0.0 • 0.0 • 0.0 • 0.0 • 0.0	MARK DATE DESCRIPTION
● 1.3 ● 1.7 ● 2.1 ● 2.8 ● ● 5.9 ● 8.4 ● 8½ ● 7.0 ● 6.0 ● 5.0 ● 4.8 ● 5.6 ● 6.7 ● 8.5 ● 8.9 ● 6.5 ● 4 P1 P1 P1 P1 P1	● 3.1 ● 2.3 ● 1.8 ● 1.3 ● 1.0 ● 0.0	
	● 3.4 ● 2.4 ● 1.8 ● 1.3 ● 1.0 ● 0.0	
	• 3.1 • 2.2 • 1.8 • 1.3 • 1.0 • 0.0 • 0.0 • 0.0 • 0.0 • 0.0 • 0.0 • 0.0	
RC1		
4 • 3.3 • 1.9 • 2.0 • 2.3 • • 4.4 • 6.7 • 7.: • 5.5 • 4.8 • 4.3 • 4.2 • 4.6 • 5.1 • 6.7 • 7.4 • 5.1 • 3		DRAWN: KDC DESIGNER: KDC
	• 2.4 • 1.9 • 1.7 • 1.7 • 4.4 • 65.0 • 4.0 • 25.5 • 0.0 • 0.0 • 0.0 • 0.0 • 0.	REVIEWED: DIO
WS1	PC1 [/] WS1 PC1 [/]	PROJECT #
		00-00-000
		SCALES
	F BUILDING E • 1.6 • 2.3 • 3.2 • 3.0 • 2.5 • 0.0 •	0
		1" = 10'-0" BAR SCALE MEASURES 1" O FULL SIZE SHEET. ADJUST
		PROJECT NAME:
	● 1.0 ● 1.3 ● 1.4 ● 1.6 ● 1.4 ● 0.0	
	• 0.0 • 0.0	ALLIANCE HOUSE
		PROJECT LOCATION: 1805 S. MAIN STREET
RECESSED CAN LIGHT @ 8' - 0" ABOVE CRADE (TXP)	FESTOON LIGHT @ 8' ABOVE GRADE (TYP)	SALT LAKE CITY, UT
ABOVE GRADE (TYP) GRADE (TYP)		
		SHEET TITLE:
		PHOTOMETRIC SITE
		PLAN SET: SHEET
		PERMIT E1.2

		L
Mark	Description	Manufacture
F	FESTOON LIGHT	Tokistar
P1	Full cut-off pole light, H=16'	Lithonia
RC1	Recessed 6" Can light	Elite Lightin
WS1	Wall Sconce down light	Kuzco